
OWNER CONTACT INFORMATION: SANS SOUCI ENTERISES 5848 DAHLIA STREET CITY OF COMMERCE CITY, CO 80022

ARCHITECT CONTACT INFORMATION: SHELTERBELT DESIGN 4420 ZUNI STREET DENVER, CO 80211 ATTN: NICOLE DELMAGE

ENGINEER CONTACT INFORMATION: OLSSON ASSOCIATES 5285 MCWHINNEY BLVD. LOVELAND, CO 80538 ATTN: MIKE MAURER

LANDSCAPE ARCHITECT CONTACT INFORMATION:

WENK ASSOCIATES ATTN: TYREL R. STURGEON

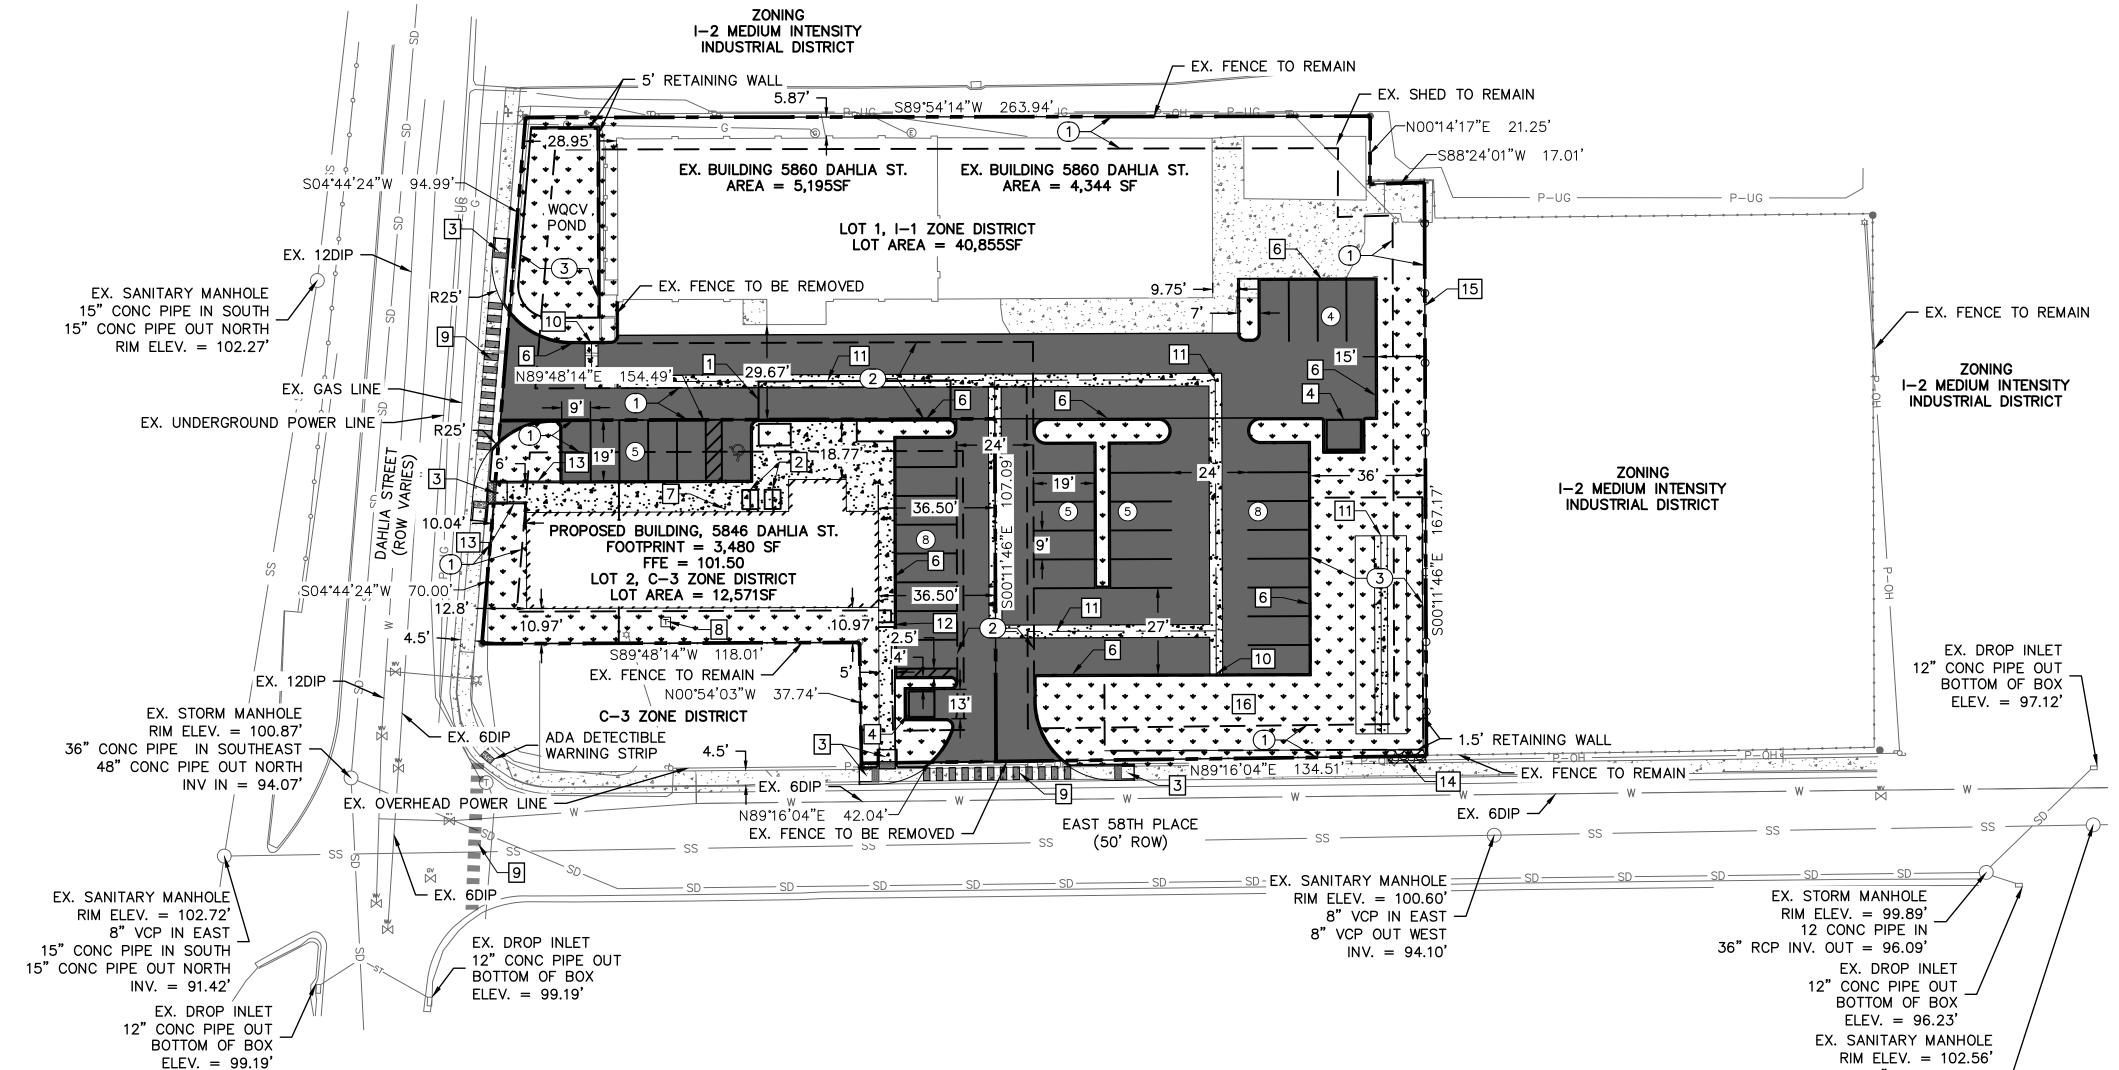

KEYNOTES:

 $1 - 12' \times 60'$ LOADING ZONE

2 - 5'x6' BIKE RACKS 2 BIKES PER RACK

3 – ADA RAMP

4 - TRASH ENCLOSURE

5 – HEADER CURB

6 - VERTICAL SPILL CURB

7 - MAIN PUBLIC ENTRANCE, SEE SHEET A1.0

8 - TRANSFORMER PAD

9 - CROSS WALK STRIPING

10 - CURB CUT

11 - CONCRETE VALLEY PAN

12 - CHASE DRAIN

13 - HAND RAIL

14 - POND EMERGENCY SPILLWAY

15 – PROPOSED FENCE

16 - WQCV & DETENTION POND

9	Sheet List Table								
Sheet Number	Sheet Title								
C1.0	SITE PLAN								
C2.0	UTILITY PLAN								
C3.0	GRADING AND DRAINAGE PLAN								
L1.0	LANDSCAPE PLAN								
L2.0	LANDSCAPE NOTES & TABLES								
A1.0	EXTERIOR ELEVATIONS								
A2.0	SITE ELEMENTS ELEVATIONS								
E1.0	SITE PHOTOMETRIC PLAN								
E1.1	PHOTOMETRIC DETAILS								

EAS	EMENT TABLE
1	10' UTILITY EASEMENT
2	24' CROSS ACCESS EMERGENCY ACCESS EASEMENT
3	DRAINAGE EASEMENT

PROJECT SUMMARY TAE	BLE
5846 DAHLIA STREET	5850 DAHLIA STREET
LOT B	LOT A
182307	7400059
0.29 ACRES (12,571 SF)	0.94 ACRES (40,855 SF)
4,080 SF	9,540 SF
3,480 SF	9,540 SF
600 SF	-
0.06 ACRES (2,813 SF)	0.21 ACRES (9,342 SF)
0.32	0.23
13	22
13	22
BUSINESS (B) & MERCANTILE (M)	-
TYPE V-B	-
CURRENT I-2, PROPOSED C-3	CURRENT I-2, PROPOSED I-1
8	8
8	8
	5846 DAHLIA STREET LOT B 182307 0.29 ACRES (12,571 SF) 4,080 SF 3,480 SF 600 SF 0.06 ACRES (2,813 SF) 0.32 13 13 BUSINESS (B) & MERCANTILE (M) TYPE V-B CURRENT I-2, PROPOSED C-3 8

8" VCP IN EAST 8" VCP OUT WEST


5846 DAHLIA ST., COMMERCE CITY, COLORADO

A PORTION THE SOUTH HALF OF THE NORTHWEST QUARTER OF THE

SOUTHEAST QUARTER OF SECTION 7, TOWNSHIP 3, RANGE 67 WEST OF

THE 6TH P.M. CITY OF COMMERCE CITY

COUNTY OF ADAMS, STATE OF COLORADO

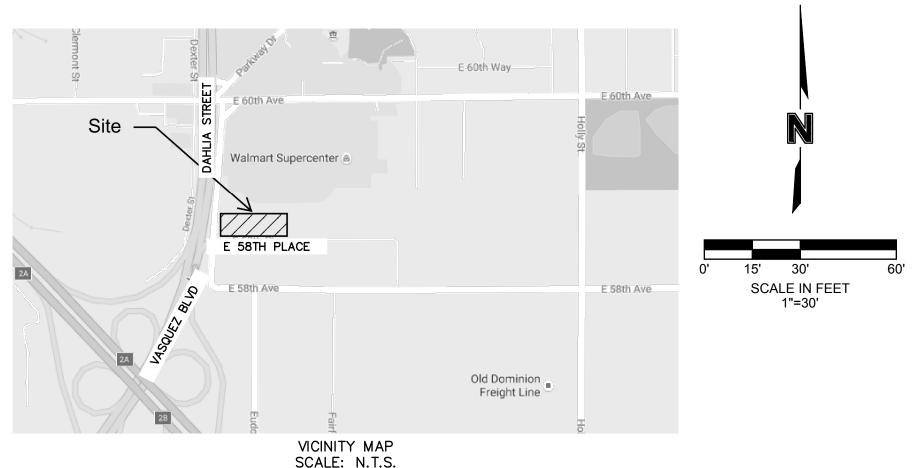

LEGEND

EXISTING		PROPOSED
	PROPERTY LINE FLOWLINE BACK OF CURB EASEMENT SETBACK LINE	
	PARKING STALL COUNT PER ROV	v (7)
	OVERHEAD POWER	——————————————————————————————————————
	GRASS LANDSCAPING	
A Company of the Comp	ONCRETE SIDEWALK/VALLEY PAN	
	ASPHALT PAVEMENT	
	BUILDING	
	- FENCE	

ADA SIGN TYP.

TYPICAL ADA STALL LAYOUT

SCALE: 1'=10'

- 1. PAVEMENT SHALL EITHER BE CONCRETE OR ASPHALT. MATERIAL TO BE DETERMINED AT TIME OF CONSTRUCTION.
- 2. LIGHTING NOTE: IN THE INTEREST OF COMPATIBILITY OF SURROUNDING LAND USES, ILLUMINATION OF ANY KIND ON PRIVATE PROPERTY SHALL BE DIRECTED AND CONTROLLED IN SUCH A MANNER SO THAT THERE SHALL BE NO DIRECT RAYS OF LIGHT WHICH EXTEND BEYOND THE BOUNDARIES OF THE PROPERTY FROM WHICH IT
- TRASH ENCLOSURE NOTE: TRASH ENCLOSURES SHALL BE CONSTRUCTED TO A MINIMUM HEIGHT OF SIX (6) FEET AND OF THE SAME OR COMPLEMENTARY MATERIAL AND COLOR AS THE MAIN BUILDING.
- SCREENING NOTE: ROOF MOUNTED ELECTRICAL AND MECHANICAL EQUIPMENT SHALL BE PLACED OR SCREENED SUCH THAT THE EQUIPMENT IS NOT VISIBLE FROM ANY POINT. SUCH EQUIPMENT SHALL BE SCREENED WITH THE SAME MATERIALS AND COLORS AS THE MAIN BUILDING.
- SIGNAGE NOTE: APPROVAL OF A SIGN PERMIT IS REQUIRED IN ADDITION TO DEVELOPMENT PLAN APPROVAL. SIGN LOCATIONS SHOWN ON THE DEVELOPMENT PLAN WILL BE REVIEWED FOR POSSIBLE CONFLICTS WITH SIGHT TRIANGLES AND EASEMENTS, HOWEVER, THESE SIGNS WILL NOT BE APPROVED BY THE DEVELOPMENT PLAN REVIEW PROCESS OR APPROVAL OF THIS DEVELOPMENT PLAN. ALL SIGNS MUST CONFORM TO THE CITY OF COMMERCE CITY'S SIGN CODE.
- FENCING NOTE: APPROVAL OF A FENCE PERMIT IS REQUIRED IN ADDITION TO DEVELOPMENT PLAN APPROVAL. ALL FENCES MUST CONFORM TO THE CITY OF COMMERCE CITY'S FENCING REQUIREMENTS.
- DOWNSPOUT NOTE: NO ROOF DOWNSPOUT OUTFALLS WILL BE ALLOWED TO DRAIN OVER SIDEWALKS, BIKE PATHS, OR ANY OTHER PEDESTRIAN ROUTE. AMERICANS WITH DISABILITIES NOTE: THE APPLICANT HAS THE OBLIGATION TO COMPLY
- OF THIS DEVELOPMENT PLAN DOES NOT CONSTITUTE COMPLIANCE WITH THIS ACT. CONSTRUCTION NOTE: THE APPROVAL OF THIS DEVELOPMENT PLAN DOES NOT CONSTITUTE FINAL APPROVAL OF GRADING, DRAINAGE, UTILITY, PUBLIC IMPROVEMENTS AND BUILDING PLANS. THESE PLANS MUST BE REVIEWED AND APPROVED BY THE

13. FENCING WILL BE INSTALLED ALONG THE FULL LENGTH OF THE PROPERTY LINE DIVIDING

WITH ALL APPLICABLE REQUIREMENTS OF THE AMERICAN DISABILITIES ACT. APPROVAL

- APPROPRIATE AGENCY PRIOR TO THE ISSUANCE OF BUILDING PERMITS. 10. <u>UNDERGROUND UTILITY NOTE</u>: ALL OVERHEAD UTILITIES SERVING THIS SITE MUST BE PLACED UNDERGROUND PER LAND DEVELOPMENT CODE.
- 11. CURB IS ALL SPILL CURB UNLESS OTHERWISE NOTED. SEE SHEET C3.0 FOR CURB 12. SURROUNDING SIDEWALKS SHALL BE REPAIRED AND REPLACED AS NECESSARY.

BENCHMARK

THE SITE FROM THE I-2 LOT TO THE EAST.

ASSUMED 100.0' ON THE CONCRETE FINISHED FLOOR AT THE EASTERLY END OF THE BRICK BUILDING AS SHOWN AND DESCRIBED HEREON. WITH ALL OTHER ELEVATION INFORMATION SHOWN HEREON RELATED THERETO.

BASIS OF BEARING

ASSUMED BEARING OF NORTH 00°15'10" WEST LINE OF THE SOUTHEAST QUATER OF SECTION 7.

> PARCEL IDENTIFICATION NUMBER 182307400059

CITY STAFF CERTIFICATE

APPROVED BY THE DEPARTMENT OF COMMUNITY DEVELOPMENT OF THE CITY OF COMMERCE CITY, THIS ____ DAY OF _____, A.D. ____.

12/22/2016 SHEET

DEPARTMENT OF COMMUNITY DEVELOPMENT SIGNATURE

® W

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FOR CONSTRUCTION.

NO RESPONSIBILITY FOR (HORIZONTAL OR VERTICAL). T EXISTING UTILITIES SHOWN ON THIS DRAWING HAVE BEEN PLOTTED FROM THE BEST AVAILABLE INFORMATION. IT HOWEVER THE RESPONSIBILIT VERIFY THE LOCATION OF ALI UTILITIES PRIOR TO THE



COMMENCEMENT OF ANY

CALL 811 SEVENTY-TWO HOURS PRIOR TO DIGGING, GRADING OF EXCAVATING FOR THE MARKING OF

checked by: MM approved by: QA/QC by: 016-1205 project no.: drawing no.: C_SIT_161205.dwg


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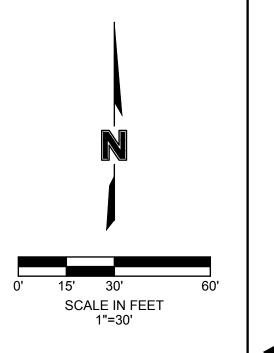
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- 2 5'x6' BIKE RACKS 2 BIKES PER RACK
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5846 DAHLIA ST., COMMERCE CITY, COLORADO

A PORTION THE SOUTH HALF OF THE NORTHWEST QUARTER OF THE SOUTHEAST QUARTER OF SECTION 7, TOWNSHIP 3, RANGE 67 WEST OF THE 6TH P.M. CITY OF COMMERCE CITY COUNTY OF ADAMS, STATE OF COLORADO



LEGEND

EXISTING		PROPOSED
	PROPERTY LINE FLOWLINE BACK OF CURB EASEMENT SETBACK LINE WATER LINE	
WM	WATER METER	•
WV 200	WATER VALVE	и оо
SS SS SS	SANITARY SEWER SANITARY CLEANOUT GAS LINE	
P-OH	OVERHEAD POWER	
	UNDERGROUND POWER	——————————————————————————————————————
——————————————————————————————————————	STORM SEWER	
(D)	STORM MANHOLE	
	GRATE INLET	

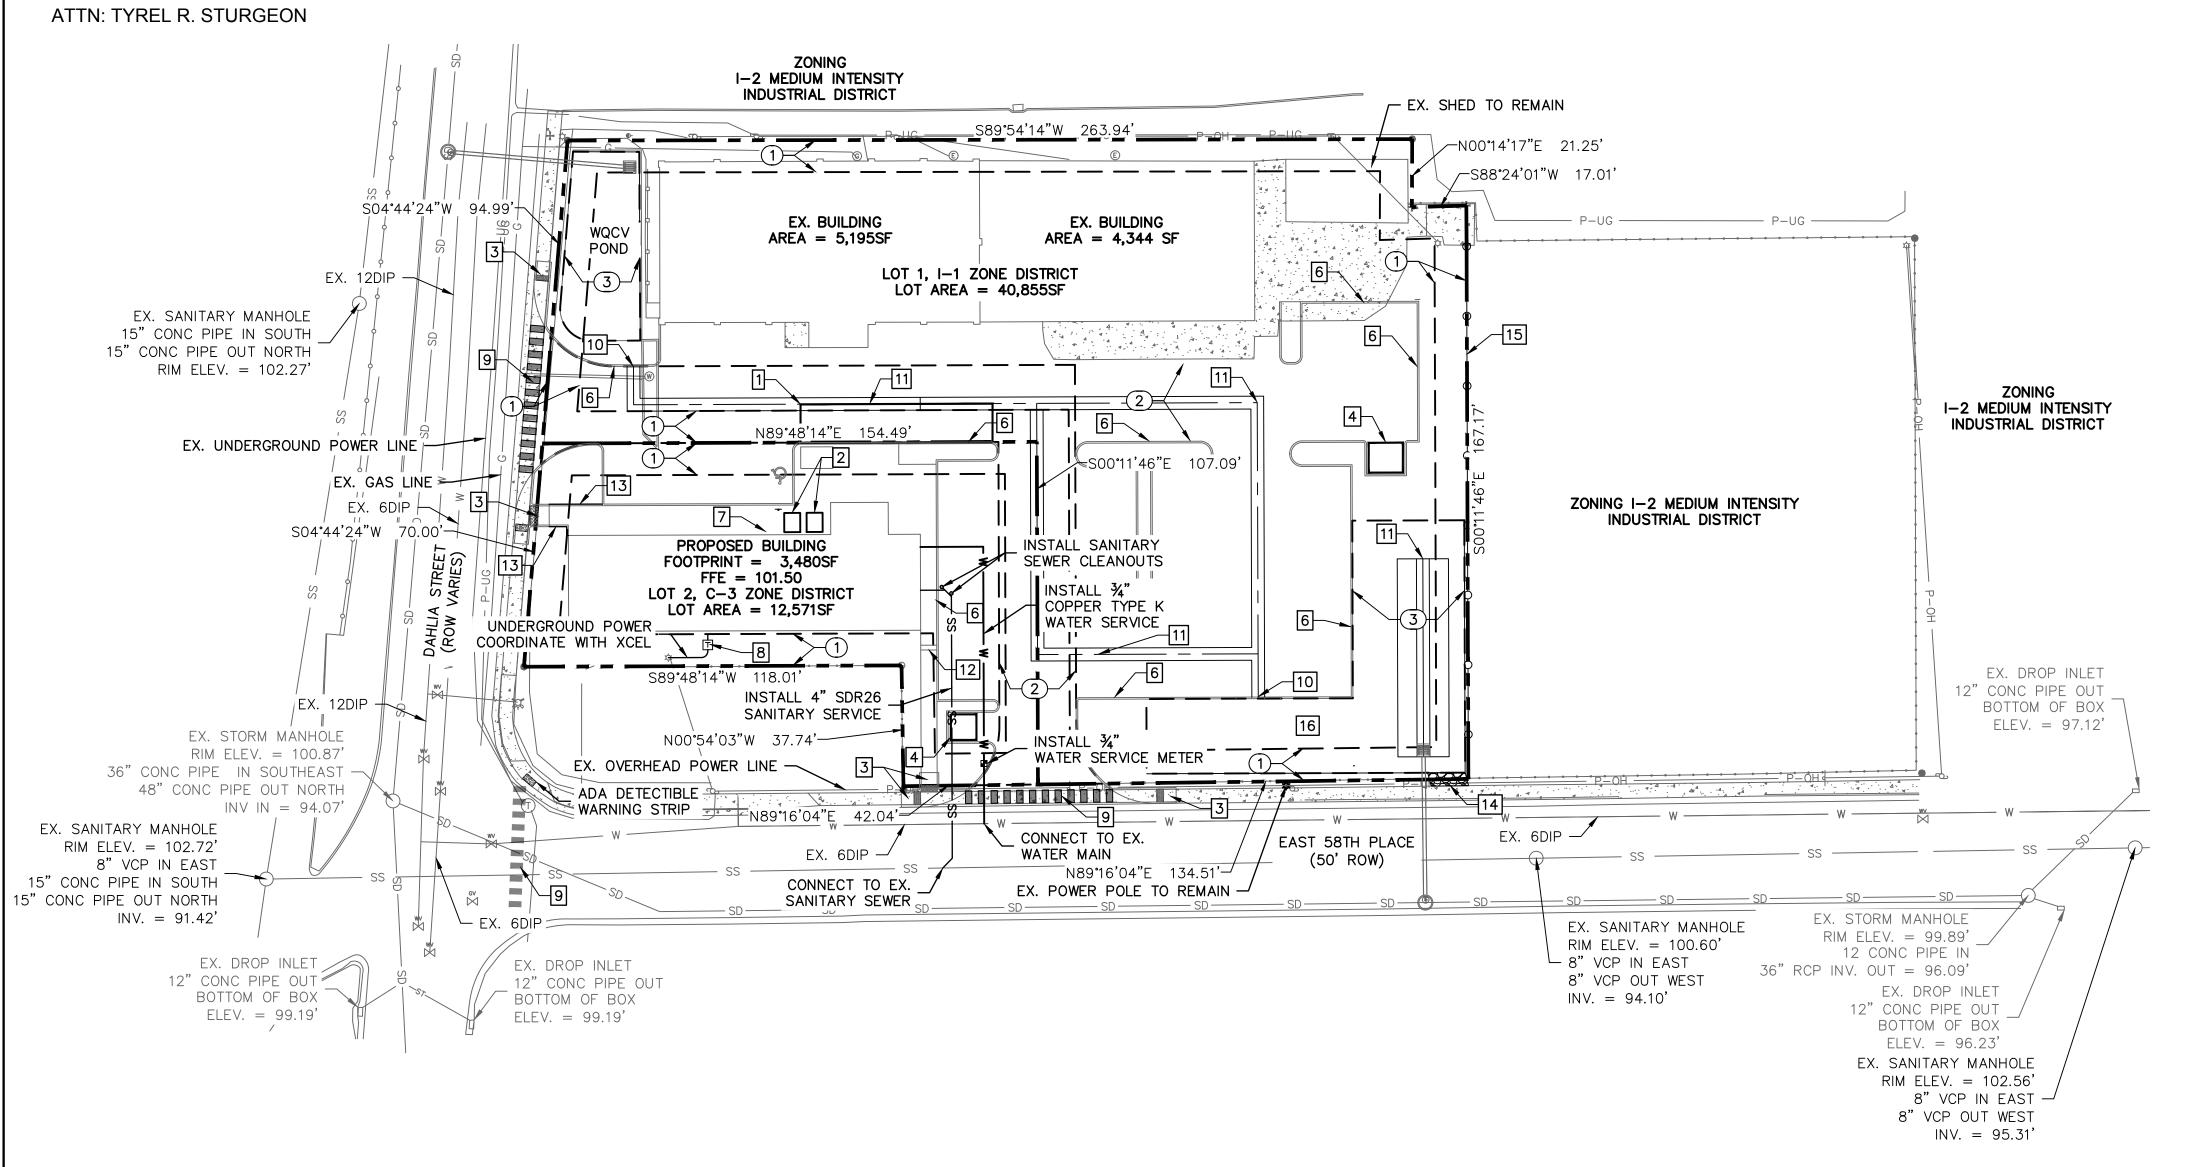WATER AND SEWER GENERAL NOTES

- 1. ALL CONSTRUCTION WORK TO BE ACCEPTED BY THE CITY SHALL CONFORM THE THE CITY OF COMMERCE CITY CONSTRUCTION SPECIFICATIONS AND DESIGN
- 2. ALL OVER LOT GRADING IN THE RIGHT-OF-WAY OR EASEMENT SHALL BE COMPLETED PRIOR TO INSTALLING POTABLE WATER, SANITARY SEWER, OR NON-POTABLE IRRIGATION LINES.
- 3. CONTRACTOR SHALL VERIFY ALL UTILITY LOCATIONS PRIOR TO CONSTRUCTION CALL UTILITY NOTIFICATION CENTER OF COLORADO AT 1-800-922-1987 OR DIAL 811 FOR UTILITY LOCATES 48 HOURS PRIOR TO ANY EXCAVATION WORK.
- 4. MAINTAIN A MINIMUM OF TEN (10) FEET HORIZONTAL CLEAR DISTANCE SEPARATION BETWEEN POTABLE WATER MAINS/SERVICES AND SANITARY SEWER OR NON-POTABLE IRRIGATION MAINS/SERVICES. POTABLE WATER MAINS/SERVICES ARE TO BE LOCATED 18-INCHES MINIMUM ABOVE THE SANITARY SEWER OR NON-POTABLE IRRIGATION MAINS/SERVICES. IF FIELD CONDITIONS VARY FROM THOSE SHOWN ON THESE PLANS AND THE SANITARY SEWER OR NON-POTABLE MAINS/SERVICES CANNOT BE LOCATED BELOW THE WATER MAIN OR SERVICE. A CLEAR VERTICAL DISTANCE OF EIGHTEEN (18) INCHES BELOW CANNOT BE MAINTAINED, OR A MINIMUM THE (10) FOOT HORIZONTAL SEPARATION CANNOT BE ACHIEVED, THE CITY SHALL BE CONTACTED IMMEDIATELY TO REVIEW THE SITUATION.
- 5. IN ALL INSTANCES WHERE A WATER LINE LOWERING, POTABLE OR NON-POTABLE, IS REQUIRED DUE TO UNFORESEEN FIELD CONDITIONS, A DETAILED DRAWING SHALL BE PROVIDED TO THE CITY FOR ACCEPTANCE PRIOR TO PERFORMING THE
- 6. WHERE POTABLE WATER, SANITARY SEWER, AND NON-POTABLE IRRIGATION LINES ARE LOCATED IN COMMON UTILITY EASEMENT AREAS, THERE SHALL BE NO OTHER UTILITIES LOCATED HORIZONTALLY WITHIN TEN (10) FEET OF EITHER LINE EXCEPT AT APPROVED CROSSINGS.
- 7. CONTRACTOR SHALL NOTIFY THE CITY ONE (1) WEEK PRIOR TO COMMENCING WORK AFTER CITY ACCEPTED CONSTRUCTION DRAWINGS HAVE BEEN DISTRIBUTED AND A PRECONSTRUCITON MEETING HAS BEEN HELD WITH THE CITY. 8. CONTRACTOR SHALL POTHOLE ALL EXISTING UTILITIES TO BE CROSSED BY
- POTABLE WATER, SANITARY SEWER, OR NON-POTABLE IRRIGATION LINES AT LEAST 24 HOURS PRIOR TO CROSSING TO ENSURE 18" MINIMUM CLEARANCE FOR OPEN CUT CROSSINGS AND 36" MINIMUM CLEARANCE FOR BORED CROSSINGS. HORIZONTAL AND VERTICAL LOCATION OF CROSSED EXISTING UTILITIES SHALL BE RECORDED ON THE AS-CONSTRUCTED RECORD DRAWINGS. 9. SHOULD ANY VARIATIONS BEFORE OR DURING CONSTRUCTION TO THE POTABLE
- WATER DISTRIBUTION, SANITARY SEWER COLLECTION, OR NON-POTABLE IRRIGATION SYSTEM DESIGNS BE CONSIDERED, NOTICE MUST FIRST BE GIVEN TO THE CITY TO DETERMINE IF IT NEEDS ACCEPTANCE BY THE CITY. IF SO, A NEW PLAN SHALL BE DRAWN AND SUBMITTED TO THE CITY FOR ACCEPTANCE BY THE DESIGN ENGINEER 72 HOURS PRIOR TO CONSTRUCTION.
- 10. THE FINAL CONSTRUCTION PLANS ARE VALID FOR CONSTRUCTION ONE (1) YEAR FROM THE DATE OF CITY SIGNATURE ACCEPTANCE.

EASEMENT TABLE

ASSUMED 100.0' ON THE CONCRETE FINISHED FLOOR

ASSUMED BEARING OF NORTH 00°15'10" WEST LINE OF

AT THE EASTERLY END OF THE BRICK BUILDING AS

SHOWN AND DESCRIBED HEREON. WITH ALL OTHER

ELEVATION INFORMATION SHOWN HEREON RELATED

10' UTILITY EASEMENT

24' CROSS ACCESS EMERGENCY ACCESS

EASEMENT

DRAINAGE EASEMENT

1

2

3

BENCHMARK

BASIS OF BEARING

THE SOUTHEAST QUATER OF SECTION 7.

- 11. VERIFICATION SURVEY TOP OF PIPE ELEVATIONS AT ALL POTABLE AND NON-POTABLE WATER LINE VALVES, AND SANITARY SEWER MANHOLE INVERTS SHALL BE SURVEYED AND PROVIDED TO THE CITY BY THE DESIGN ENGINNER FOR ACCEPTANCE PRIOR TO PAVING CONSTRUCTION. THE VERIFICATION SURVEY SHALL ALSO PROVIDE SEWER PIPE SLOPES AND LENGTH AND PROPOSED FINISHED GROUND ELEVATIONS AT ALL VALVE BOXES AND MANHOLE RIM ELEVATIONS.
- 12. ALL UTILITY CONDUIT CROSSINGS OF POTABLE WATER, SANITARY SEWER AND NON-POTABLE IRRIGATION LINES SHALL BE ENCASED IN HIGH DENSITY POLYETHYLENE (HDPE) PIPE, WITH A MINIMUM STANDARD DIMENSION RATIO (SDR) 11 ACROSS THE ENTIRE EASEMENT OR RIGHT-OF-WAY WIDTH. THE ENCASEMENT JOINT SHALL BE BUTT FUSED. FLEXIBLE JOINTS ARE NOT ALLOWED. 13. PRIOR TO EXCAVATION AND CONSTRUCTION OVER AND NEAR THE EXISTING
- WATER AND SEWER MAINS, PLEASE CONTACT THE WATER AND SEWER DEPARTMENT RIGHT-OF-WAY STAFF, TO COMPLETE THE APPLICABLE DOCUMENTATION TO WORK WITHIN THE RIGHT OF WAY AND EASEMENTS.
- 14. COORDINATE UTILITIES AT BUILDING WITH PLUMBING PLANS. 15. UNDERGROUND UTILITY NOTE: ALL OVERHEAD UTILITIES SERVING THIS SITE MUST BE PLACED UNDERGROUND PER LAND DEVELOPMENT CODE.

PARCEL IDENTIFICATION NUMBER 182307400059

CITY STAFF CERTIFICATE

APPROVED BY THE DEPARTMENT OF COMMUNITY DEVELOPMENT OF THE CITY OF COMMERCE CITY, THIS ____ DAY OF _____, A.D. ____.

approved by: MM QA/QC by: 016-1205 project no.: drawing no.: 12/22/2016

DEPARTMENT OF COMMUNITY DEVELOPMENT SIGNATURE

® W

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Know what's **below**. **Call** before you dig CALL 811 SEVENTY-TWO HOURS PRIOR TO DIGGING, GRADING OR EXCAVATING FOR THE MARKING OF NDERGROUND MEMBER UTILITIES

REVISIONS DESCRIPTION					REVISIONS
DATE					
MEV.					
					2016

checked by: C_UTL_161205.dwg

> SHEET C2.0

OWNER CONTACT INFORMATION: SANS SOUCI ENTERISES 5848 DAHLIA STREET CITY OF COMMERCE CITY, CO 80022

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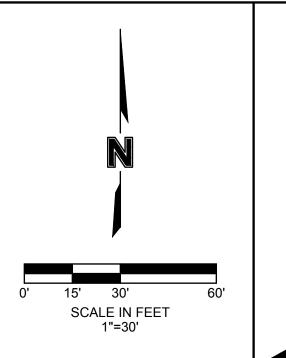
ATTN: NICOLE DELMAGE

ATTN: MIKE MAURER

LANDSCAPE ARCHITECT CONTACT INFORMATION: WENK ASSOCIATES

5846 DAHLIA ST., COMMERCE CITY, COLORADO

A PORTION THE SOUTH HALF OF THE NORTHWEST QUARTER OF THE SOUTHEAST QUARTER OF SECTION 7. TOWNSHIP 3. RANGE 67 WEST OF THE 6TH P.M. CITY OF COMMERCE CITY COUNTY OF ADAMS, STATE OF COLORADO



LEGEND

EXISTING

×—ELEV

PROPERTY LINE FLOWLINE BACK OF CUR EASEMENT SETBACK LIN GRADE BREAK MAJOR CONTOURS MINOR COUNTOUR **INVERTED CROWN** WATER LINE SANITARY SEWER STORM MANHOLE **GRATE INLET**

STORM SEWER **SPOT ELEVATION** FLOW ARROW FINISH FLOOR ELEVATION

HIGH POINT LOW POINT **SIDEWALK FLOWLINE** MATCH EXISTING GRADE **BOTTOM OF WALL** TOP OF WALL **BOTTOM OF POND**

DISTURBING ACTIVITY COMMENCING. GRADES SHOWN ARE FINISHED GRADES.

EQUAL TO SIDEWALK ELEVATIONS.

THE BASE COURSE IS APPROVED.

TYPE OF PAVING MATERIAL USED.

NOTIFY ENGINEER OF ANY DISCREPANCIES.

GRADING NOTES

x-ELEV FFE MEG **BOW** TOW

PROPOSED

UTILITIES PRIOR TO THE COMMENCEMENT OF ANY CONSTRUCTION ACTIVITIE

CALL 811 SEVENTY-TWO HOURS

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BY REGULATORY AGENCIES AND

THER PROFESSIONALS, AND IS

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EXISTING UTILITIES SHOWN ON

HOWEVER THE RESPONSIBILIT

OF THE CONTRACTOR TO FIELD

VERIFY THE LOCATION OF ALI

DOCUMENT IS NOT TO BE USED

® W

Call before you did PRIOR TO DIGGING, GRADING OF EXCAVATING FOR THE MARKING O

GEOTECHNICAL RECOMMENDATIONS AND SPECIFICATIONS. 8. CONTRACTOR SHALL FIELD VERIFY ALL INFORMATION AND IMMEDIATELY 9. OUTFLOW CURB AND GUTTER SHALL BE INSTALLED AS INDICATED. TRANSITION FROM INFLOW CURB AND GUTTER TO OUTFLOW CURB AND

GUTTER SHALL BE A 3' MINIMUM. 10. CONTRACTOR SHALL CONDUCT SAMPLING AND TESTING QUALITY CONTROL PER THE PLANS AND GEOTECHNICAL RECOMMENDATIONS. 11. PRIOR TO BEGINNING ANY CUT OR FILL, CONTRACTOR SHALL STRIP EXISTING GROUND TO REMOVE ALL VEGETATION.

1. EROSION CONTROL MEASURES MUST BE IN PLACE PRIOR TO ANY LAND

THE CONTOUR LINES AND BUILDING FLOOR ELEVATIONS SHOWN ARE TO

FINISH GRADE FOR SURFACE OF PAVEMENT, TOP OF SIDEWALKS AND

4. TOP OF CURB AND SIDEWALK ELEVATIONS AT LOCATIONS OTHER THAN

ELEVATIONS UNLESS OTHERWISE NOTED. IN AREAS WITH SIDEWALK

ABUTTING BACK OF CURB, TOP OF CURB ELEVATIONS SHALL BE

5. NO ASPHALT OR CONCRETE PAVING SHALL BE INSTALLED UNTIL ALL

6. NO PAVING SHALL BE INSTALLED UNTIL APPROVAL IS GIVEN AS TO

THE SIDEWALK AROUND THE BUILDING SHALL BE 0.5' ABOVE GUTTER

UTILITIES IN OR CROSSING PAVED AREAS HAVE BEEN INSTALLED AND

THICKNESS TO DEDUCT FOR GRADING LINE ELEVATIONS.

7. BASE MATERIAL AND ASPHALT SHALL BE INSTALLED PER

CURS, TOP OF FLOOR SLABS, ETC. ALL SPOT ELEVATIONS SHOWN ARE TO FLOWLINE UNLESS OTHERWISE INDICATED. REFER TO TYPICAL SECTIONS FOR MULCH, SOD, PAVING, SLAB AND AGGREGATE BASE

12. TOPSOIL SHALL BE REMOVED WHERE STRUCTURES ARE TO BE BUILT. TOPSOIL SHALL BE STORED CLEAR OF THE CONSTRUCTION AREA. CONTRACTOR SHALL TAKE CARE TO PREVENT THE TOPSOIL FROM BECOMING MIXED WITH SUBSOIL 13. UNLESS OTHERWISE DIRECTED BY THE GEOTECHNICAL ENGINEER,

COMPLETION OF STRIPPING AND/OR EXCAVATION IN AREAS TO PROVIDE SUPPORT FOR INTERIOR/EXTERIOR SLABS, TO RECEIVE PAVEMENT, AND TO RECEIVE FILL SHALL BE SCARIFIED TO MINIMUM DEPTH OR 8-INCHES AND COMPACTED IN ACCORDANCE WITH QUALITY CONTROL NOTES.

14. DO NOT PLACE FILL OR BACKFILL IF FILL OR BACKFILL MATERIAL IS FROZEN OR IF THE SURFACE UPON WHICH FILL OR BACKFILL IS TO BE PLACED IS FROZEN.

15. BACKFILL AROUND STRUCTURES: CONTRACTOR SHALL PLACE BACKFILL AROUND CONCRETE STRUCTURES ONLY AFTER THE CONCRETE HAS ATTAINED THE SPECIFIED COMPRESSIVE STRENGTH. CONTRACTOR SHALL REMOVE ALL FORM MATERIALS AND TRASH FROM THE EXCAVATION BEFORE PLACING ANY BACKFILL. CONTRACTOR SHALL NOT OPERATE EARTH-MOVING EQUIPMENT WITHIN 5 FEEL OF WALLS OF CONCRETE STRUCTURES FOR THE PURPOSE OF DEPOSITING OR COMPACTING BACKFILL MATERIAL. CONTRACTOR SHALL COMPACT BACKFILL ADJACENT TO CONCRETE WALLS WITH HAND-OPERATED TAMPERS OR SIMILAR EQUIPMENT THAT WILL NOT DAMAGE THE STRUCTURE. CONTRACTOR SHALL PLACE FILL IN LIFTS NOT MORE THAN 8 INCHES THICK PRIOR TO COMPACTION AND COMPACT IN ACCORDANCE WITH QUALITY CONTROL NOTES.

16. <u>DOWNSPOUT NOTE</u>: NO ROOF DOWNSPOUT OUTFALLS WILL BE ALLOWED TO DRAIN OVER SIDEWALKS, BIKE PATHS, OR ANY OTHER PEDESTRIAN

17. CONTRACTOR TO OBTAIN THE NPDES PERMIT NOTE.

PARCEL IDENTIFICATION NUMBER 182307400059

CITY STAFF CERTIFICATE


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MM QA/QC by: 016-1205 project no.: drawing no.: C_GRD_161205.dw 12/22/2016 SHEET

C3.0

checked by:

DEPARTMENT OF COMMUNITY DEVELOPMENT SIGNATUR

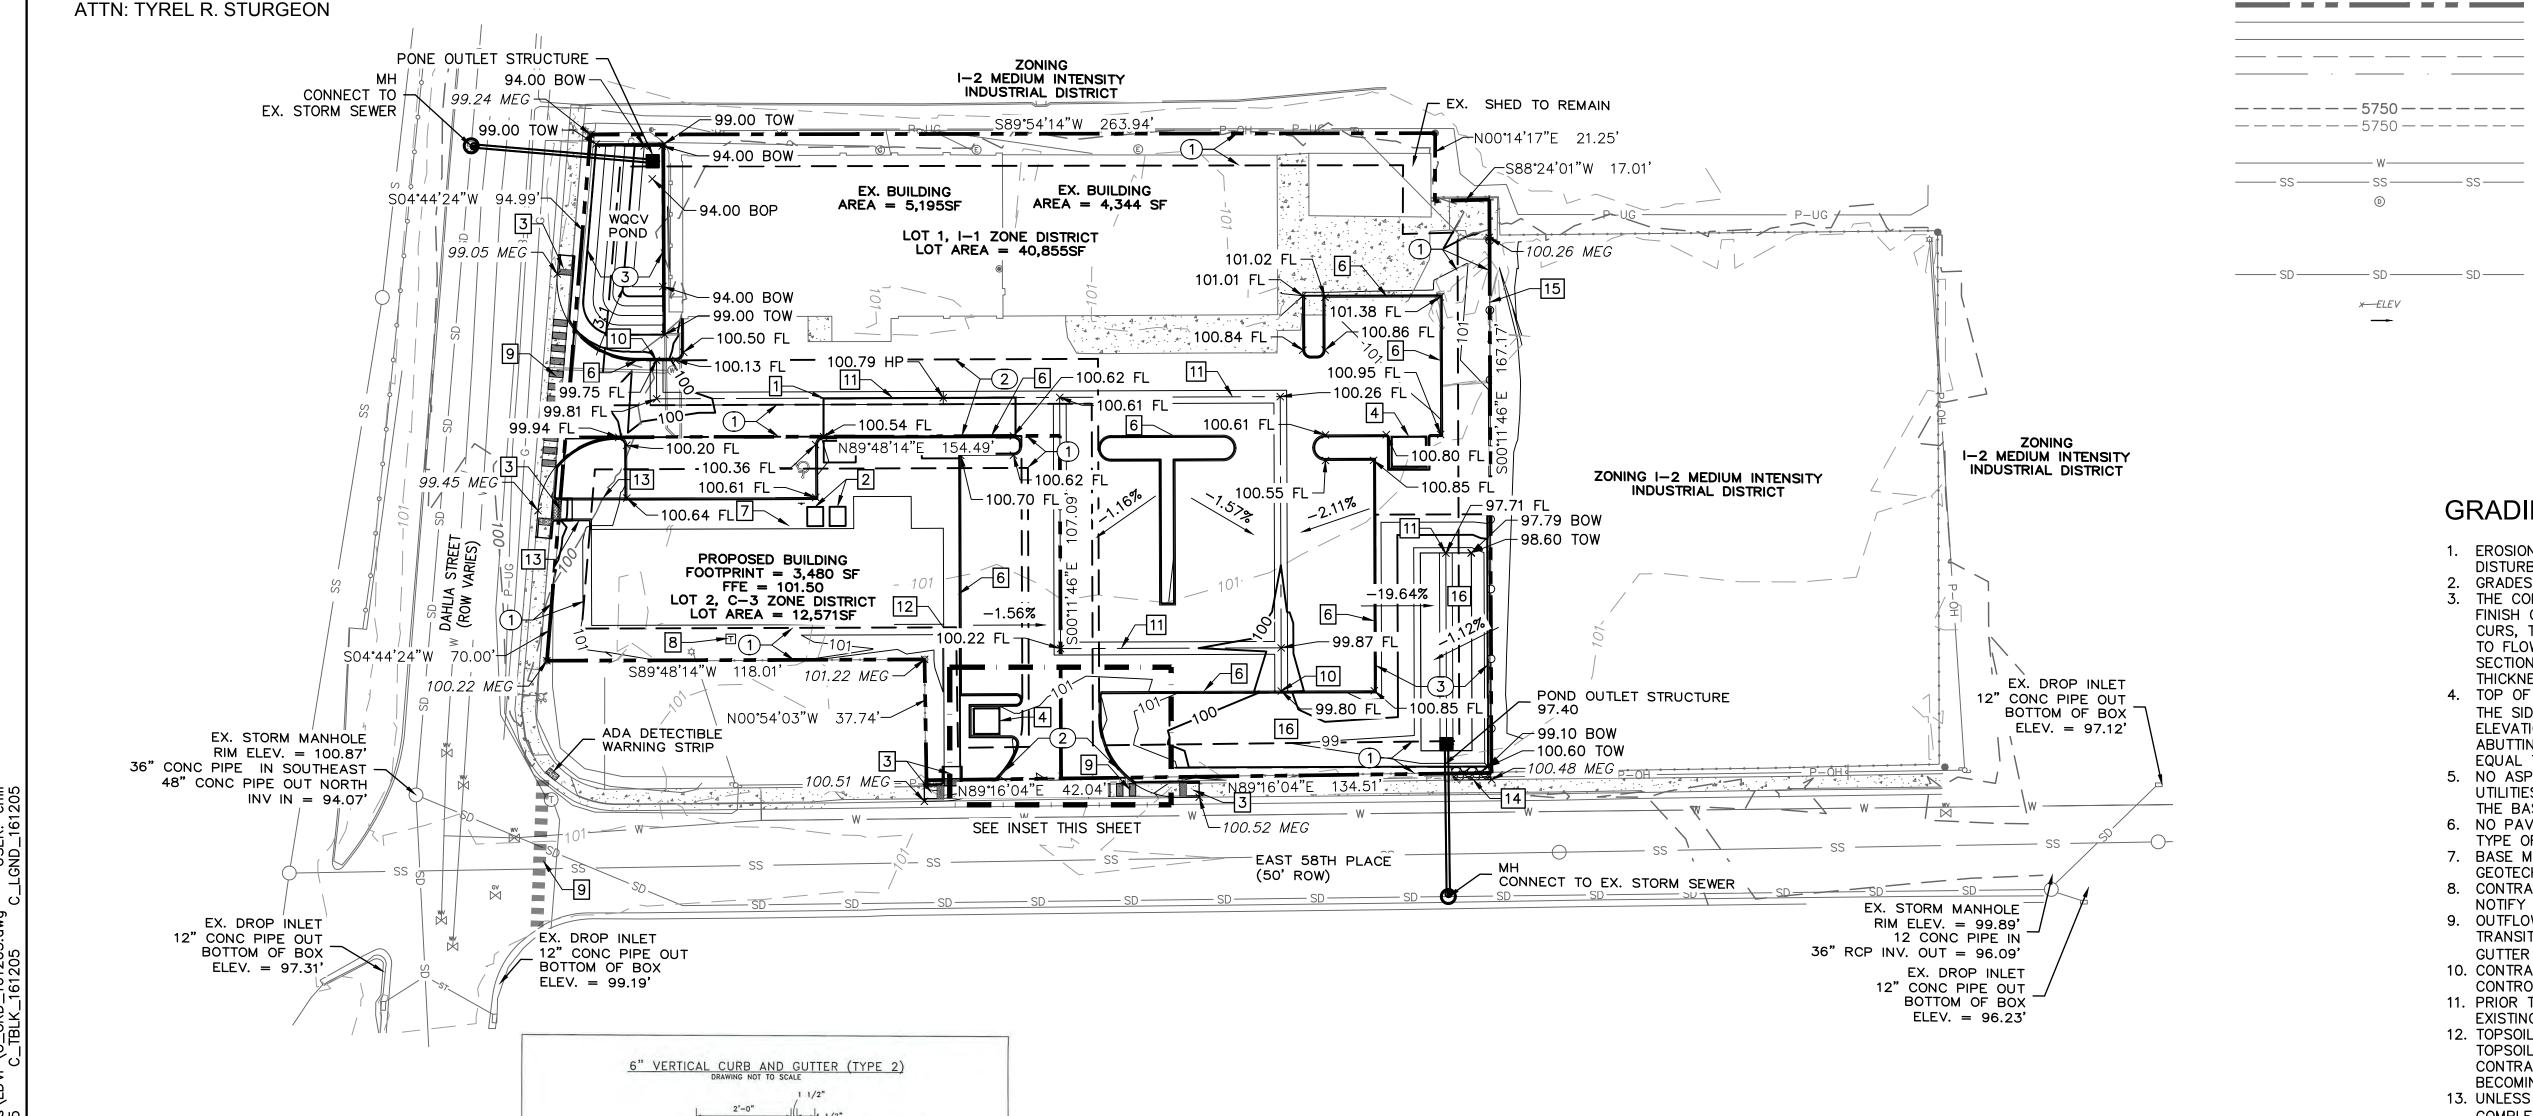

KEYNOTES:

 $1 - 12' \times 60'$ LOADING ZONE

2 - 5'x6' BIKE RACKS 2 BIKES PER RACK

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16 - WQCV & DETENTION POND

SECTION IIB

SECTION B

3. 3/4" \$\psi \times 12" DEFORMED REINFORCING BARS AT 6 FT, SPACING.
BARS TO BE GROUTED IN 1-1/2" \$\psi\$ HOLES IN EXISTING CONCRETE.
GROUT TO CONSIST OF 2 PARTS CLEAN SAND AND 1 PART CEMENT.

308-07

4. 9" CURB HEIGHT, 1'-9" OVERALL HEIGHT FOR MEDIAN.

SPILL SECTION

SECTION IB

DEPARTMENT OF PUBLIC WORKS

VERTICAL CURB SECTIONS

ENGINEERING CONSTRUCTION STANDARDS

~101.44 FL **─**101.27 FL P-OH

SOUTH ACCESS DRIVE

SCALE: 1'=10'

BENCHMARK

1

2

3

ASSUMED 100.0' ON THE CONCRETE FINISHED FLOOR AT THE EASTERLY END OF THE BRICK BUILDING AS SHOWN AND DESCRIBED HEREON. WITH ALL OTHER ELEVATION INFORMATION SHOWN HEREON RELATED

EASEMENT TABLE

10' UTILITY EASEMENT

24' CROSS ACCESS EMERGENCY ACCESS

EASEMENT

DRAINAGE EASEMENT


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A PORTION OF THE SOUTH HALF OF THE NORTHWEST QUARTER OF THE SOUTHEAST QUARTER OF SECTION 7, TOWNSHIP 3, RANGE 67 WEST OF THE 6TH P.M., CITY OF COMMERCE CITY, COUNTY OF ADAMS, STATE OF COLORADO







PLANT	SCHE	DULE			<i>L.</i> (BOTTT LAGE	OU N.O.W. WIDTT	(5) JO⊓				
SYMB. QTY	ABBREV.	BOTANICAL NAME	COMMON NAME	MIN. SIZE	MIN. SPACING	NOTES	SYMB. QTY ABBRE\	. BOTANICAL NAME	COMMON NAME	MIN. SIZE	MIN. SPACING	NOTES
	ORNAN	MENTAL TREES					ORN	AMENTAL GRASSES				
<u>10</u>	PC	PYRUS CALLERYANA 'CHANTICLEER'	CHANTICLEER PEAR	2" CAL.	AS SHOWN	B&B	⊙ 155 CAO	CALAMGROSTIS X ACUTIFLORA 'OVER	DAM' OVERDAM FEATHER REED	GRASS 1 GAL.	18" O.C.	CONT.
·cm	DECID	JOUS SHADE TREES								4.001	CI O C	CONT
$\{\cdot\}$ 2	KP	CELTIS OCCIDENTALIS ' PRAIRIE PRIDE'	PRAIRIE PRIDE HACKBERRY	2" CAL.	AS SHOWN	B&B	32 ERR	ERIANTHUS RAVENNA	RAVENNA GRASS	1 GAL.	6' O.C.	CONT.
• 5	GD	GYMNOCLADUS DIOICUS	KENTUCKY COFFEE TREE	2" CAL.	AS SHOWN	B&B	* 81 FOG	FESTUCA OVINA GLAUCA	BLUE FESCUE	1 GAL.	18" O.C.	CONT.
5	GT	GLEDISTIA TRIACANTHOS ENERMIS	SHADEMASTER HONEY LOCUS	ST 2" CAL.	AS SHOWN	B&B.	9 17 MRU	MUHLENBERGIA REVERCHONI 'UNDAN	NUTED' UNDAUNTED MUHLY GRAS	1 GAL.	18" O.C.	CONT.
	01	GLEBIOTIA TAIMOMATTIOG ENERAMIO	OTIVIDE WINOTE INTO THE PEOPLE	71 2 O/L.	AC OHOWN	DQD.				1 GAL.	2' O.C.	CONT.
· 3	QM	QUERCUS MACROCARPA	BUR OAK	2" CAL	AS SHOWN	B&B	9 91 PAH	PENNISETUM ALOPECUROIDES 'HAME	LN' HAMELN DWARF FOUNTAIN	GRASS		
(+) 8	TC	TILIA CORDATA 'GREENSPIRE'	GREENSPIRE LINDEN	2" CAL.	AS SHOWN	B&B	GRO	JNDCOVERS				
							₹) } 55 JUH	JUNIPEROUS HORIZONTALIS	CREEPING JUNIPER	5 GAL.	6' O.C.	CONT.
	SHRUE	es					⊕ 148 PHS	PHLOX SUBULATA	CREEPING PHLOX	4" POT	18" O.C.	CONT.
① <u>11</u>	COR	CORNUS SERICEA	REDOSIER DOGWOOD	5 GAL.	6' O.C.	CONT.	√ 47 POV	DOTENTILLA MEDNIA	ODEEDING DOTENTILLA	5.041	01.0.0	CONT
~ ·	=110			- 0.11		0.01/5		POTENTILLA VERNA	CREEPING POTENTILLA	5 GAL.	3' O.C.	CONT.
(∴) 11	ENS	ERICAMERIA NAUSEOSA SPECIOSA	DWARF BLUE RABBITBRUSH	5 GAL.	4' O.C.	CONT.	RIDΔ	RIAN SEED MIX				
① 13	FON	FORESTIERA NEOMEXICANA	NEW MEXICAN PRIVET	5 GAL.	4' O.C.	CONT.	COMMON NAM WOOLY SEDG	IE SCIENTIFIC NAME	LB/AC (PLS)			CITY STA

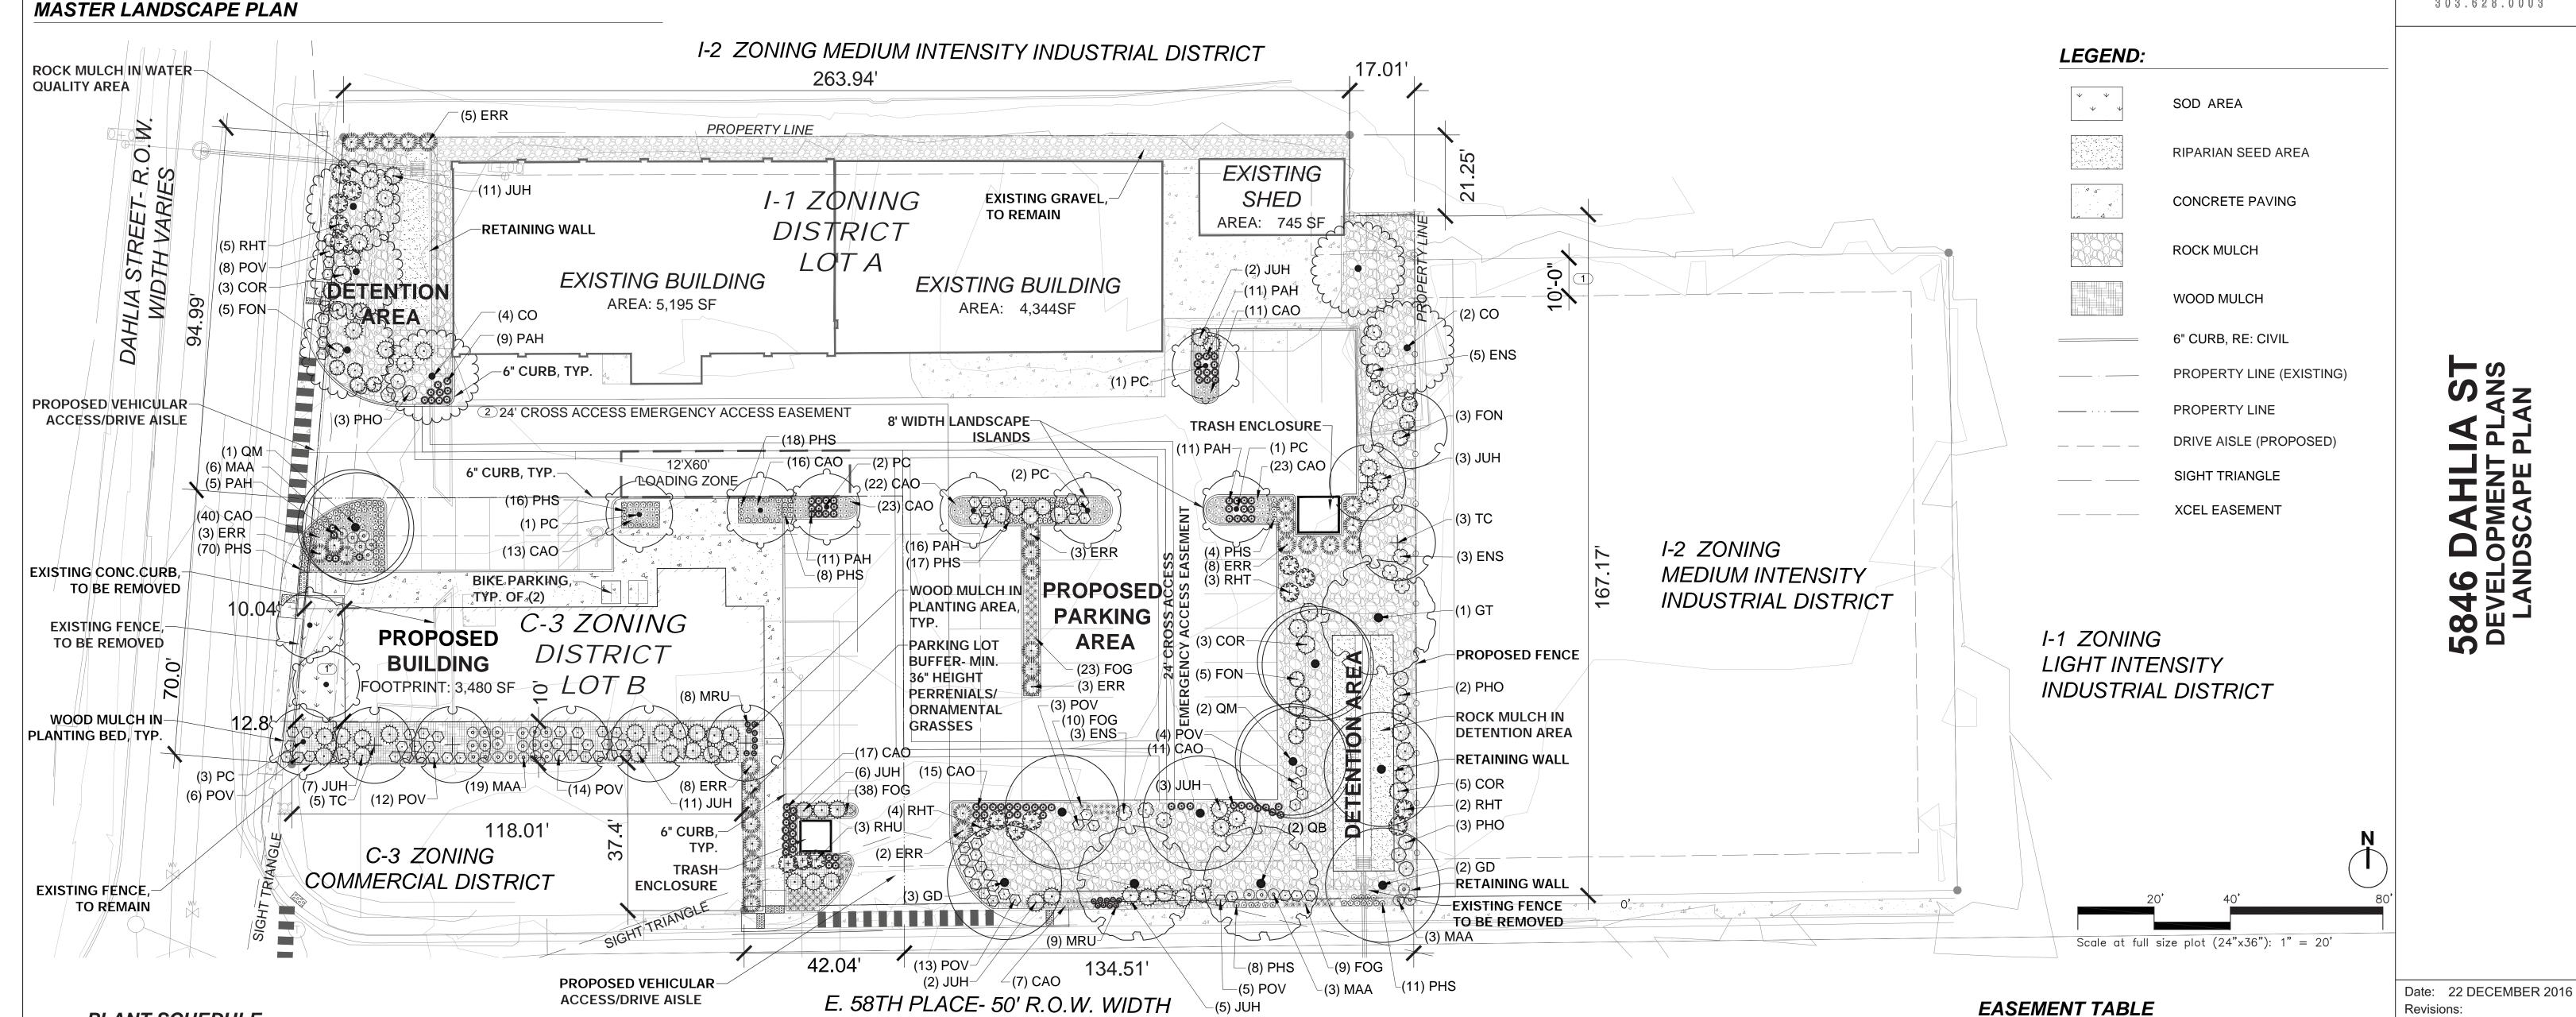MAHONIA AQUIFOLIUM 'COMPACTA'

COLORADO GROWN KENTUCKY BLUEGRASS SOD BLEND. BLEND SHALL CONTAIN A MINIMUM OF 3

IMPROVED VARIETIES, OF WHICH AT LEAST ONE VARIETY IS AN AGGRESSIVE TYPE

PHYSOCARPUS OPULIFOLIUS

BLUEGRASS SOD MIX

COMPACT OREGON GRAPE HOLLY 5 GAL.

MOUNTAIN NINEBARK

THREE LEAF SUMAC

3' O.C.

4' O.C.

6' O.C.

5 GAL.

CONT.

CONT.

CONT.

NEBRASKA SEDGE

SWITCHGRASS

ALKALI SACATON

WILD BERGAMOT SWAMP VERBENA

INLAND SALTGRASS

CREEPING SPIKERUSH

GREEN NEEDLEGRASS

NUTTALL'S SUNFLOWER

PRAIRIE CORDGRASS

WESTERN WHEATGRASS

CAREX NEBRASCENSIS

ELEOCHARIS PALUSTRIS

SPARTINA PECTINATA

ACHILLEA MILLEFOLIUM

SPOROBOLUS AIROIDES

MONARDRA FISTULOSA VERBENA HASTATA

WER HELIANTHUS NUTTALLII
JUNCUS ARTICUSS SSP. LITTORALIS

PASCOPYRUM SMITHII

PANICUM VREGATUM

NASELLA VIRIDULA

DISTICHLIS SPICATA

PARCEL IDENTIFICATION NUMBER: 182307400059

10' UTLITY EASMENT

DRAINAGE EASEMENT

24' CROSS ACCESS EMERGENCY VEHICLE EASEMENT

	10
CITY STAFF CERTIFICATE	
APPROVED BY THE DEPARTMENT OF COMMUNIT	Y DEVELOPMENT OF
THE CITY OF COMMERCE CITY, THISDAY OF	, 2016.

DEPARTMENT OF COMMUNITY DEVELOPMENT

Landscape Plan

Drawing Number:

5285 McWhinney Blvd, Ste160 Loveland, CO 80538 (970) 461-7733 contact: Mike Maurer

1. 28 JULY 2016 2. 12 OCTOBER 2016

PROJECT TEAM:

Landscape Architect Wenk Associates 1130 31st St, Ste 101 Denver, CO 80205 (303) 628-0003 contact: Tyrel Sturgeon tsturgeon@wenkla.com

Civil Engineer Olsson Associates

Master Planner/Architect ShelterBelt Design 4470 Zuni Street Denver, CO 80211 (303) 704-2812 contact: Nicole Delmage

3. 17 NOVEMBER 2016 4. 16 DECEMBER 2016

A PORTION OF THE SOUTH HALF OF THE NORTHWEST QUARTER OF THE SOUTHEAST QUARTER OF SECTION 7, TOWNSHIP 3, RANGE 67 WEST OF THE 6TH P.M., CITY OF COMMERCE CITY, COUNTY OF ADAMS, STATE OF COLORADO

ASSOCIATES PLANNERS & LANDSCAPE ARCHITECTS 303.628.0003

Date: 22 DECEMBER 2016 Revisions:

1. 28 JULY 2016 2. 12 OCTOBER 2016 3. 17 NOVEMBER 2016 4. 16 DECEMBER 2016

PROJECT TEAM:

Master Planner/Architect ShelterBelt Design 4470 Zuni Street Denver, CO 80211 (303) 704-2812 contact: Nicole Delmage

Landscape Architect Wenk Associates 1130 31st St, Ste 101

Denver, CO 80205 (303) 628-0003 contact: Tyrel Sturgeon tsturgeon@wenkla.com Civil Engineer

Olsson Associates 5285 McWhinney Blvd, Ste160

Loveland, CO 80538 (970) 461-7733 contact: Mike Maurer

Landscape Notes & Tables

Drawing Number:

PARCEL IDENTIFICATION NUMBER: 182307400059

DAY OF

APPROVED BY THE DEPARTMENT OF COMMUNITY DEVELOPMENT OF

CITY STAFF CERTIFICATE

THE CITY OF COMMERCE CITY. THIS

DEPARTMENT OF COMMUNITY DEVELOPMENT

LANDSCAPE NOTES

1. FINAL CONSTRUCTION DOCUMENTS SHALL CONFORM TO THE REQUIREMENTS OUTLINED WITHIN THIS

2. LANDSCAPE PLANS ARE SCHEMATIC IN NATURE AND SUBJECT TO MODIFICATION TO MEET THE CITY'S REQUIREMENTS, THE DEVELOPER'S PROGRAM, OR OTHER NECESSARY REQUIREMENTS.

3. LOCATION, BUT NOT QUANTITY, OF LANDSCAPE PLANTINGS MAY BE ALTERED TO PROVIDE ADEQUATE CLEARANCE FROM THE FINAL LOCATION OF UNDERGROUND UTILITIES.

4. PLANTINGS SHALL BE IRRIGATED BY AN UNDERGROUND, AUTOMATIC IRRIGATION SYSTEM. TURF AREAS WILL BE SPRAY IRRIGATED. TREES, SHRUBS, LANDSCAPE BEDS AND TREE LAWNS LESS THAN 10' WIDE SHALL BE SUBSURFACE IRRIGATED. THE TAP AND BACKFLOW PREVENTION DEVICE SIZE AND LOCATION SHALL BE SHOWN ON IRRIGATION PLANS. LANDSCAPE AND IRRIGATION SHALL MEET THE REQUIREMENTS OF THE SOUTH ADAMS COUNTY WATER AND SANITATION DISTRICT.

5. LANDSCAPE IMPROVEMENTS IN TRACTS SHALL BE OWNED AND MAINTAINED BY THE DEVELOPER.

7. AREAS INTENDED FOR IRRIGATED AND MOWED TURF SHALL NOT EXCEED 4:1 SLOPE. NATIVE GRASSES AND SHRUB BEDS SHALL NOT EXCEED 3:1 SLOPE.

8. 30' SIGHT TRIANGLES ARE SHOWN ON THE PLANS, PER MUNICIPAL CODE. A VISION CLEARANCE AREA SHALL CONTAIN NO PLANTINGS, WALLS, STRUCTURES, OR TEMPORARY OR PERMANENT OBSTRUCTIONS EXCEEDING 2.5' IN HEIGHT, MEASURED FROM THE TOP OF THE CURB OR EXISTING GRADE, UNLESS SUCH STRUCTURE OR OBSTRUCTIONS ARE MORE THAN 80 PERCENT OPEN.

9.TOPSOIL THAT IS REMOVED DURING CONSTRUCTION ACTIVITY SHALL BE CONSERVED FOR LATER USE ON AREAS REQUIRING RE-VEGATION AND LANDSCAPING.

10. SOIL IN AREAS THAT HAVE BEEN COMPACTED OR DISTURBED DURING CONSTRUCTION SHALL BE THOROUGHLY LOOSENED. ORGANIC SOIL AMENDMENTS HALL BE INCORPORATED INTO THE SOIL AT A RATE OF A MINIMUM OF 5 CUBIC YARDS PER 1,000 SQUARE FEE OF LANDSCAPE AREA, AND TILLED TO A MINIMUM DEPTH OF 6 INCHES.

11. PLANT MATERIALS SHALL BE SELECTED FROM THE CITY'S APPROVED PLAN LIST AND LANDSCAPING

12. ALL PLANTS SHALL BE A-GRADE OR NO. 1 GRADE, FREE OF ANY DEFECTS, AND SHALL BE OF NORMAL HEALTH, HEIGHT, LEAF DENSITY, AND SPREAD APPROPRIATE TO THE SPECIES AS DEFINED BY THE AMERICAN ASSOCIATION OF NURSERYMEN STANDARDS.

13. THE CALIPER OF DECIDUOUS TREES SHALL BE MEASURED 6" ABOVE THE BASE.

14. EXISTING CONDITIONS: THERE ARE NO EXISTING LANDSCAPE IMPROVEMENTS. THEREFORE, NO LANDSCAPE IS PLANNED TO REMAIN.

15. MINIMUM PLANT SIZE REQUIREMENTS AND SOIL PREPARATION: MINIMUM PLANT SIZE REQUIREMENTS ARE 2-INCH DIAMETER (CALIPER) FOR DECIDUOUS TREES, 1.5-INCH DIAMETER FOR ORNAMENTAL TREES AND 6-FOOT HEIGHT FOR EVERGREEN TREES. MINIMUM SIZE REQUIREMENTS FOR SHRUBS IS #5 GALLON CONTAINER, ORNAMENTAL GRASSES #1 GALLON CONTAINER; PERENNIALS AND GROUND COVER 2 ¼ POTS. PLANTS SHOULD B MIXED APPROXIMATELY 50% EVERGREEN AND 50% DECIDUOUS (TREE LAWN AREAS SHALL BE DECIDUOUS SHADE TREES). MINIMUM SOIL PREPARATION FOR PLANTING SHALL BE 5 CUBIC YARDS OF ORGANIC SOIL AMENDMENT TILLED TO A DEPTH OF 6-INCHES FOR EVERY 1,000SF OF LANDSCAPE AREA.

16. STREET TREES: THE PLANNING DIVISION HAS IDENTIFIED SPECIFIC DECIDUOUS TREE SPECIES TO BE PLANTED WITHIN TREE LAWN AREAS. ALL TREES CHOSEN FOR TREE LAWN APPLICATIONS MUST BE SELECTED FROM THE APPROVED PLANT LIST.

17. WEED BARRIER: POROUS FABRIC MUST BE USED IN PLANTED BEDS. PLASTIC WEED BARRIERS ARE PROHIBITED

18. EDGING. PLASTIC OR FIBERGLASS EDGING IS FAVORABLE TO METAL. HOWEVER, METAL EDGING MAY BE USED PROVIDED IT HAS A ROLLOVER TOP OR A PROTECTIVE CAP.

19. IMPLEMENTATION AND COORDINATION OF THE LANDSCAPE PLAN. THE DEVELOPER SHALL ENSURE THAT THE LANDSCAPE PLAN IS CLOSELY COORDINATED WITH PLANS PREPARED BY OTHER CONSULTANTS SO THAT THE PROPOSED GRADING, STORM DRAINAGE, OR OTHER CONSTRUCTION DOES NOT CONFLICT WITH OR PRECLUDE THE INSTALLATION AND MAINTENANCE OF LANDSCAPE ELEMENTS AS DESIGNATED ON THE LANDSCAPE PLAN.

20. IRRIGATION. ALL LANDSCAPE AREAS AND PLANT MATERIALS MUST BE WATERED BY AN AUTOMATIC UNDERGROUND IRRIGATION SYSTEM. IRRIGATION SYSTEM DESIGN. INSTALLATION. OPERATION, AND MAINTENANCE SHALL CONFORM TO THE REQUIREMENTS OF THE SOUTH ADAMS COUNTY WATER AND SANITATION DISTRICT (SACWSD). APPROVAL OF THIS LANDSCAPE PLAN DOES NOT CONSTITUTE APPROVAL FROM THE SACWSD.

THE DEVELOPER, HIS SUCCESSORS, AND ASSIGNS, SHALL BE RESPONSIBLE FOR INSTALLATION, MAINTENANCE AND REPLACEMENT OF ALL LANDSCAPING MATERIALS SHOWN OR INDICATED ON THE APPROVED LANDSCAPE PLAN, INCLUDING THE LANDSCAPING WITHIN THE RIGHT-OF- WAY

LANDSCAPING SHALL BE CONTINUOUSLY MAINTAINED INCLUDING NECESSARY WATERING, WEEDING, PRUNING, PEST CONTROL, AND REPLACEMENT OF DEAD OR DISEASED PLANT MATERIAL SHALL BE OF THE SAME TYPE OF PLANT MATERIAL AS SET FORTH IN THE APPROVED SITE PLAN (A TREE MUST REPLACE A TREE OR A SHRUB MUST REPLACE A SHRUB). ANY REPLACEMENT SHALL OCCUR IN THE NEXT PLANTING SEASON, BUT IN NO CASE SHALL REPLACEMENT EXCEED 1 YEAR.

THIS APPROVED LANDSCAPE PLAN SHALL BE ON FILE IN THE PLANNING DIVISION. ALL LANDSCAPING WILL BE INSTALLED AS DELINEATED ON THE PLAN PRIOR TO THE ISSUANCE OF ANY CERTIFICATE OF OCCUPANCY.

22. VEHICLE PARKING NOTE: NO VEHICLE PARKING IS ALLOWED IN ANY LANDSCAPE TREATMENT AREA

LANDSCAPE STATISTICS TABLES:

LOT B:

LANDSCAPE TREATMENT AREA:

TOTAL SQUARE FEET OF LANDSCAPE AREA: 2,836 SQUARE FEET OF SOD AREA: 395 PERCENTAGE OF TOTAL LANDSCAPE AREA IN SOD: 14% SQUARE FEET OF PLANTED AREA: 2,300 SF PERCENTAGE OF TOTAL LANDSCAPE AREA IN PLANTINGS: 81% TOTAL TREES REQUIRED BY LANDSCAPE ORDINANCE: 5 **TOTAL TREES PROVIDED IN PLAN: 16** TOTAL SHRUBS REQUIRED BY LANDSCAPE ORDINANCE: 9 **TOTAL SHRUBS PROVIDED IN PLAN: 78** MULCH TYPES REQUIRED BY LANDSCAPE ORDINANCE: 2

MULCH TYPES PROVIDED IN PLAN: 2

RIGHT-OF-WAY LANDSCAPE AREA: SQUARE FEET OF LANDSCAPE IN RIGHT OF WAY: 0 STREET TREES REQUIRED BY LANDSCAPE ORDINANCE: 7 STREET TREES PROVIDED IN PLAN: 7

PARKING LOT PERIMETER LANDSCAPE:

PARKING PERIMETER TREES REQUIRED BY LANDSCAPE ORDINANCE: 4 PARKING PERIMETER TREES PROVIDED IN PLAN: 4 PARKING PERIMETER SHRUBS REQUIRED BY LANDSCAPE ORDINANCE: 20 PARKING PERIMETER SHRUBS PROVIDED IN PLAN: 23

PARKING LOT INTERIOR LANDSCAPE:

ISLANDS REQUIRED BY LANDSCAPE ORDINANCE: 0 ISLANDS PROVIDED IN PLAN: 0 MEDIANS REQUIRED BY LANDSCAPE ORDINANCE: 0 MEDIANS PROVIDED IN PLAN: 0 INTERIOR PARKING LOT TREES REQUIRED BY LANDSCAPE ORDINANCE: 1 INTERIOR PARKING LOT TREES PROVIDED IN PLAN: 2

INTERIOR PARKING LOT SHRUBS REQUIRED BY LANDSCAPE ORDINANCE: 6

INTERIOR PARKING LOT SHRUBS PROVIDED IN PLAN*: 6

LOT A:

LANDSCAPE TREATMENT AREA:

RIGHT-OF-WAY LANDSCAPE AREA:

PARKING PERIMETER TREES REQUIRED BY LANDSCAPE ORDINANCE: 14 PARKING PERIMETER TREES PROVIDED IN PLAN: 14 PARKING PERIMETER SHRUBS REQUIRED BY LANDSCAPE ORDINANCE: 70

ISLANDS REQUIRED BY LANDSCAPE ORDINANCE: 3 ISLANDS PROVIDED IN PLAN: 3 MEDIANS REQUIRED BY LANDSCAPE ORDINANCE: 0 MEDIANS PROVIDED IN PLAN: 0 INTERIOR PARKING LOT TREES REQUIRED BY LANDSCAPE ORDINANCE: 4 INTERIOR PARKING LOT TREES PROVIDED IN PLAN: 4 INTERIOR PARKING LOT SHRUBS REQUIRED BY LANDSCAPE ORDINANCE: 18

TOTAL SQUARE FEET OF LANDSCAPE AREA: 9,045

SQUARE FEET OF SOD AREA: 0 PERCENTAGE OF TOTAL LANDSCAPE AREA IN SOD: 0 SQUARE FEET OF PLANTED AREA: 6,785 PERCENTAGE OF TOTAL LANDSCAPE AREA IN PLANTINGS: 75% TOTAL TREES REQUIRED BY LANDSCAPE ORDINANCE: 15 **TOTAL TREES PROVIDED IN PLAN: 18** TOTAL SHRUBS REQUIRED BY LANDSCAPE ORDINANCE: 30 TOTAL SHRUBS PROVIDED IN PLAN: 142 MULCH TYPES REQUIRED BY LANDSCAPE ORDINANCE: 2 MULCH TYPES PROVIDED IN PLAN: 2

DETENTION/RETENTION LANDSCAPE:

DETENTION/RETENTION TREES REQUIRED BY LANDSCAPE ORDINANCE: 12 DETENTION/RETENTION TREES PROVIDED IN PLAN: 12 DETENTION/RETENTION SHRUBS REQUIRED BY LANDSCAPE ORDINANCE: 117 DETENTION/RETENTION SHRUBS PROVIDED IN PLAN: 129

SQUARE FEET OF LANDSCAPE IN RIGHT OF WAY: 0 STREET TREES REQUIRED BY LANDSCAPE ORDINANCE: 5 STREET TREES PROVIDED IN PLAN: 7

PARKING LOT PERIMETER LANDSCAPE:

PARKING PERIMETER SHRUBS PROVIDED IN PLAN: 102

PARKING LOT INTERIOR LANDSCAPE:

INTERIOR PARKING LOT SHRUBS PROVIDED IN PLAN*: 23

*DOES NOT INCLUDE PERENNIALS & ORNAMENTAL GRASSES

A PORTION OF THE SOUTH HALF OF THE NORTHWEST QUARTER OF THE SOUTHEAST QUARTER OF SECTION 7, TOWNSHIP 3, RANGE 67 WEST OF THE 6TH P.M., CITY OF COMMERCE CITY, COUNTY OF ADAMS, STATE OF COLORADO

2nd Floor

1st Floor

1st Floor

1st Floor

1st Floor

1st Floor


10'-0" min.

Building Section (West Exterior Elevation)
3/32" = 1'-0"

Cooperty line (angled)

North Exterior Elevation

1/8" = 1'-0"

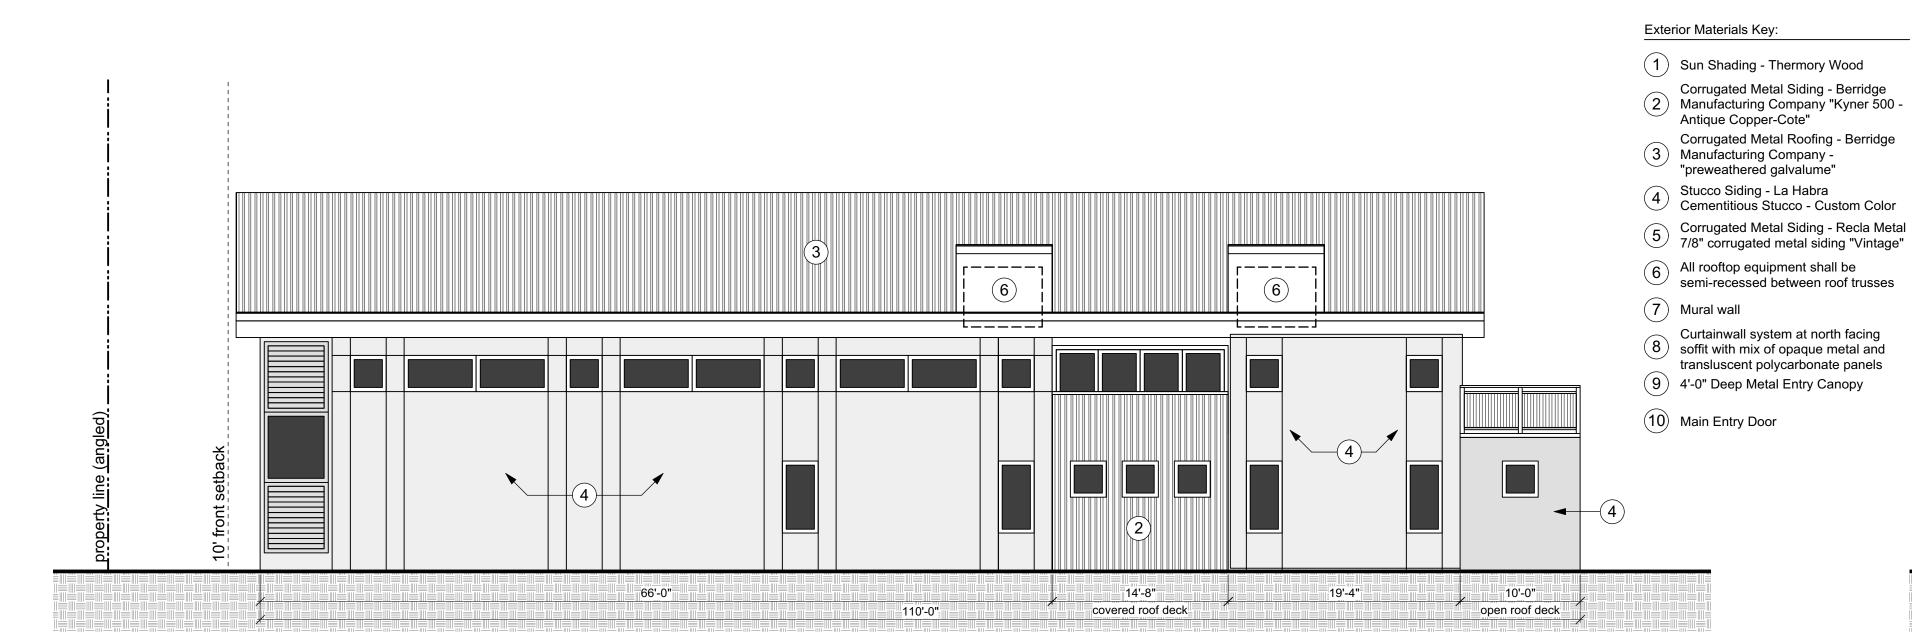


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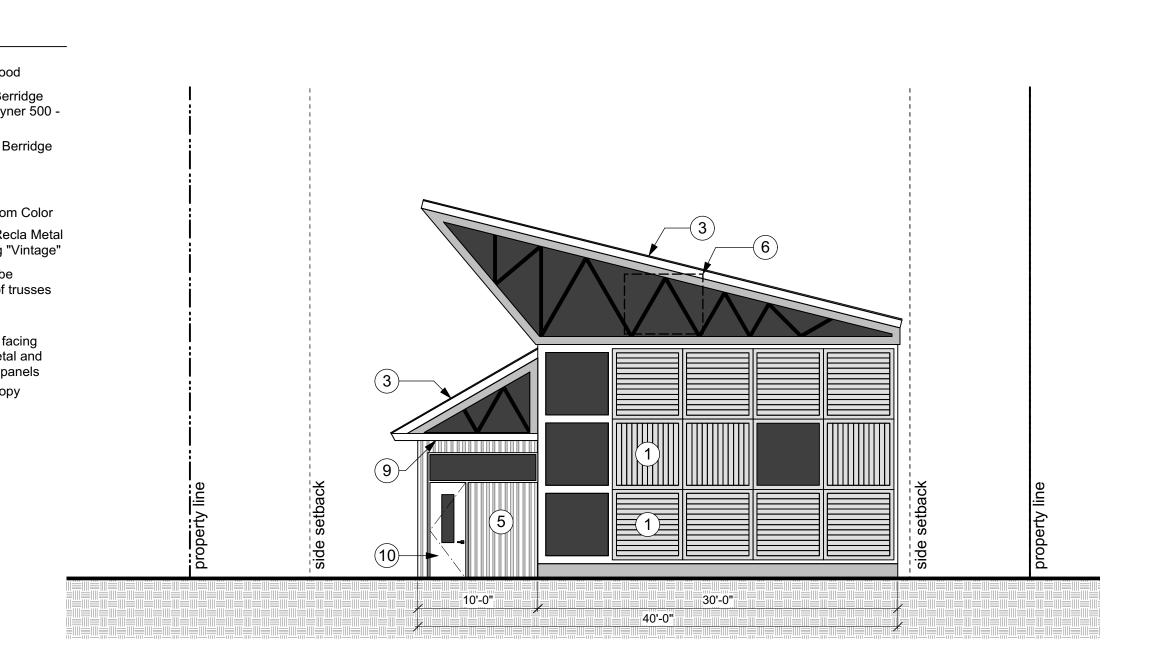
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THE CITY OF COMMERCE CITY, THIS _____DAY OF ________, 2016.

DEPARTMENT OF COMMUNITY DEVELOPMENT



East Exterior Elevation

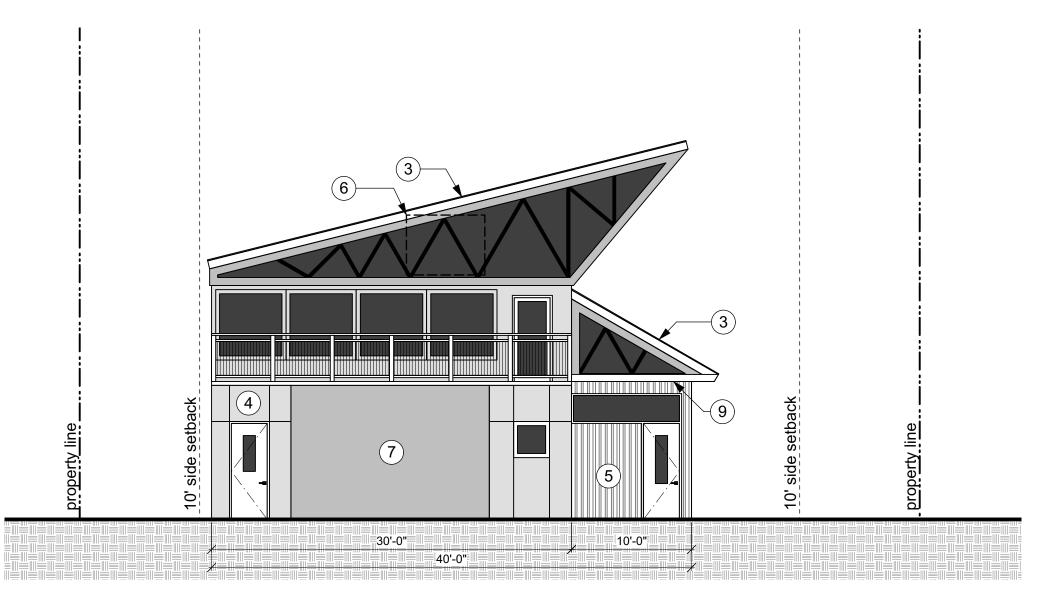

1 West Exterior Elevation
1/8" = 1'-0"

NOTICE: DUTY OF COOPERATION

Release of these plans contemplates further cooperation among the owner, his or her contractor, and the architect. Design and construction are complex. Although the architect and his/her consultants have performed their services with due care and diligence, they cannot guarantee perfection. Communication is imperfect and every contingency cannot be anticipated. Any ambiguity or discrepancy discovered by the use of these plans shall be reported immediately to the architect. Failure to notify the architect compounds misunderstanding and increases construction costs. A failure to cooperate by a simple notice to the architect shall relieve the architect from responsibility for all consequences. Changes made from the plans without consent of the architect are unauthorized and shall relieve the architect from all consequences arising out of such

Development Plan

Date: 16 December 2016

Revisions:

Commerce City, CO

PROJECT TEAM:

Master Planner/Architect ShelterBelt Design 4470 Zuni Street Denver, CO 80211 (303) 704-2812 contact: Nicole Delmage

Landscape Architect
Wenk Associates
1130 31st St, Ste 101
Denver, CO 80205
(303) 628-0003
contact: Tyrel Sturgeon
tsturgeon@wenkla.com

Civil Engineer
Olsson Associates
5285 McWhinney Blvd, Ste160
Loveland, CO 80538
(970) 461-7733
contact: Mike Maurer

Exterior Elevations

Drawing Number:

A1.0

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South Exterior Elevation

1/8" = 1'-0"

A PORTION OF THE SOUTH HALF OF THE NORTHWEST QUARTER OF THE SOUTHEAST QUARTER OF SECTION 7, TOWNSHIP 3, RANGE 67 WEST OF THE 6TH P.M., CITY OF COMMERCE CITY, COUNTY OF ADAMS, STATE OF COLORADO


PARCEL IDENTIFICATION NUMBER: 182307400059

CITY STAFF CERTIFICATE

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THE CITY OF COMMERCE CITY, THIS _____DAY OF _________, 2016.

DEPARTMENT OF COMMUNITY DEVELOPMENT

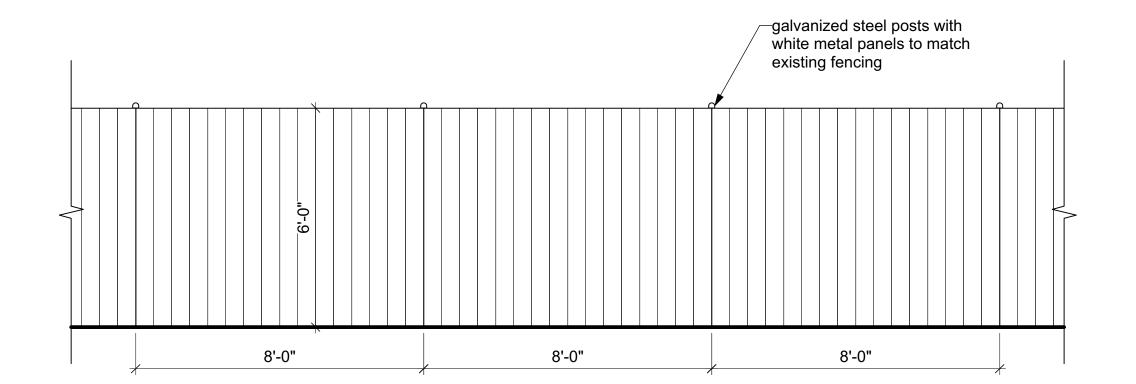

3'-3"

1.625" outside diameter steel tube


securely fasten to concrete pad

Fencing Elevation, Typical

3/8" = 1'-0"


Bike Rack Elevation, Typical


3/4" = 1'-0"

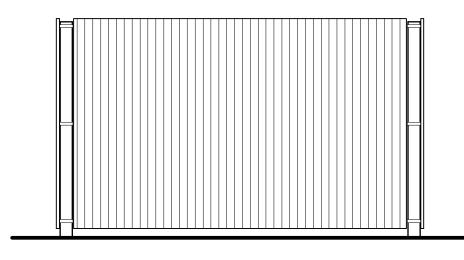

SIDE / LEFT ELEVATION

REAR ELEVATION

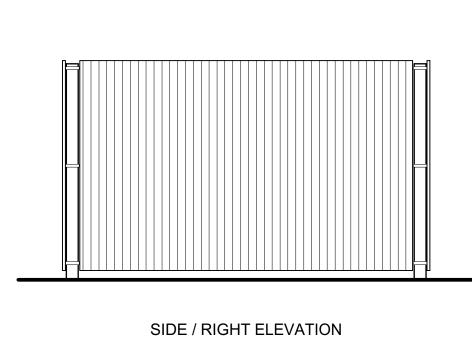

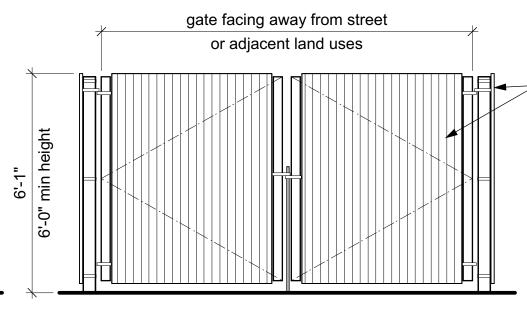

FRONT / GATE ELEVATION

1 Trash Enclosure Elevations, Typical 3/8" = 1'-0"

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Development Plan

Date: 16 December 2016

Revisions:

NOTICE: DUTY OF COOPERATION

5846 Dahlia Street Commerce City, CO

PROJECT TEAM:

Master Planner/Architect
ShelterBelt Design
4470 Zuni Street
Denver, CO 80211
(303) 704-2812
contact: Nicole Delmage

—corrugatedmetal panel to match "Recla Metal - Vintage"

color & finish installed at

primary building, typ.

Landscape Architect
Wenk Associates
1130 31st St, Ste 101
Denver, CO 80205
(303) 628-0003
contact: Tyrel Sturgeon
tsturgeon@wenkla.com

Civil Engineer
Olsson Associates
5285 McWhinney Blvd, Ste160
Loveland, CO 80538
(970) 461-7733
contact: Mike Maurer

Site Elements Elevations

Drawing Number:

A2.0

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5850 DAHLIA ST., COMMERCE CITY, COLORADO A PORTION OF THE SOUTH HALF OF THE NORTHWEST QUARTER OF THE SOUTHEAST

QUARTER OF SECTION 7, TOWNSHIP 3, RANGE 67 WEST OF THE 6TH P.M., CITY OF COMMERCE CITY, COUNTY OF ADAMS, STATE OF COLORADO




TYPE	DESCRIPTION	MANUFACTURER	CATALOG NUMBER	VOLTAGE	VOLTAGE L		LTAGE LAMP				MOUNTING INFORMATION		NOT
					aty	MATT	TYPE	WATTS	LOCATION	BOF/RFD/OFH	l		
EAI	LED AREA LIGHT, TYPE 4 DIST.	PHILIPS-GARDCO	P2I-DIM-AI-I-4-70LA-NM-UNV-XX	UNIV	-	70	LED	70	POLE	30'-0"			
										<i>o</i> F H	l		
EA2	LED AREA LIGHT, TYPE 4 DIST.	PHILIPS-GARDCO	P2I-DIM-AI-2-4-70LA-NW-UNV-XX	UNI✓	1	70	LED	70	POLE	30'-0"			
	TWIN HEAD									<i>o</i> F H	i		
EA3	LED AREA LIGHT, TYPE 3 DIST.	PHILIPS-GARDCO	P2I-DIM-AI-I-3-70LA-NM-UNV-XX	UNIV	1	70	LED	70	POLE	30'-0"	i		
										OFH	i		
EMI	LED GOOSENECK BARNLIGHT,	BARN LIGHT ELECTRIC	G-WHBI5-PC-LED-XXX-GXX-XXX	120	1	9	LED	9	SURFACE	12'-0"	<u> </u>		
	850 LUMENS		850LED-2700K-FLAT-120V						MALL	BOF	i		

A. EC TO CONFIRM FINISHES OF FIXTURES PRIOR TO PURCHASE. B. PROVIDE LUMINAIRES SHOWN AS SHADED WITH EMERGENCY BATTERY BALLASTS, EMERGENCY LUMINAIRES SHALL SENSE UN-SWITCHED POWER TO THE SPACE AND OPERATED AUTOMATICALLY UPON LOSS OF NORMAL POWER. ALL SHADED LUMINAIRES WITH 2FT AND 4FT LAMPS SHALL HAVE ONE (I) 90 MINUTE RATED, TWO LAMP, 1400 LUMEN EMERGENCY BALLAST. ALL SHADED LUMINAIRES WITH COMPACT FLUORESCENT LAMPS SHALL HAVE A FACTORY INSTALLED 90 MINUTE EMERGENCY BALLAST. ALL EMERGENCY LUMINAIRES SHALL HAVE REMOTE TEST SWITCHES AND VISIBLE INDICATING LIGHTS. CONNECT THE EMERGENCY BATTERY BALLAST TO THE UN-SWITCHED LEG OF THE LIGHTING CIRCUIT INDICATED.

I. CONFIRM GOOSENECK MOUNTING ARM WITH OWNER PRIOR TO PURCHASE

Statistics						
Description	Symbol	Avg	Max	Min	Max/Min	Avg/Min
Parking Lot	Ж	1.4 fc	11.9 fc	0.1 fc	119.0:1	14.0:1
Property Line	+	0.1 fc	0.8 fc	0.0 fc	N/A	N/A
Sidewalk	Ж	1.8 fc	3.2 fc	0.0 fc	N/A	N/A
Site	+	0.7 fc	11.9 fc	0.0 fc	N/A	N/A

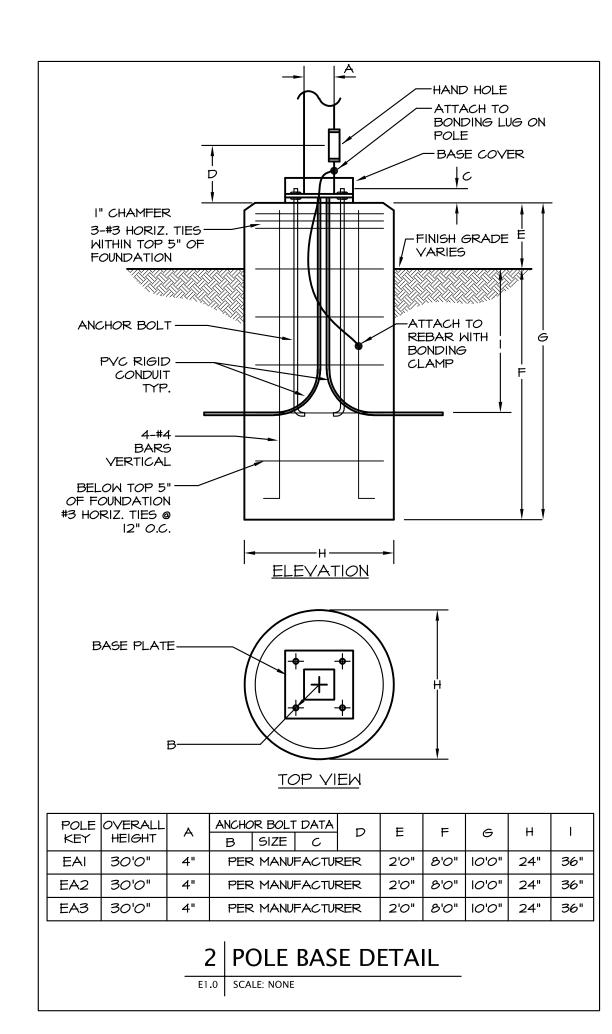


PARCEL IDENTIFICATION NUMBER: 182307400059

CITY STAFF CERTIFICATE APPROVED BY THE DEPARTMENT OF COMMUNITY DEVELOPMENT OF THE CITY OF COMMERCE CITY, THIS DAY OF

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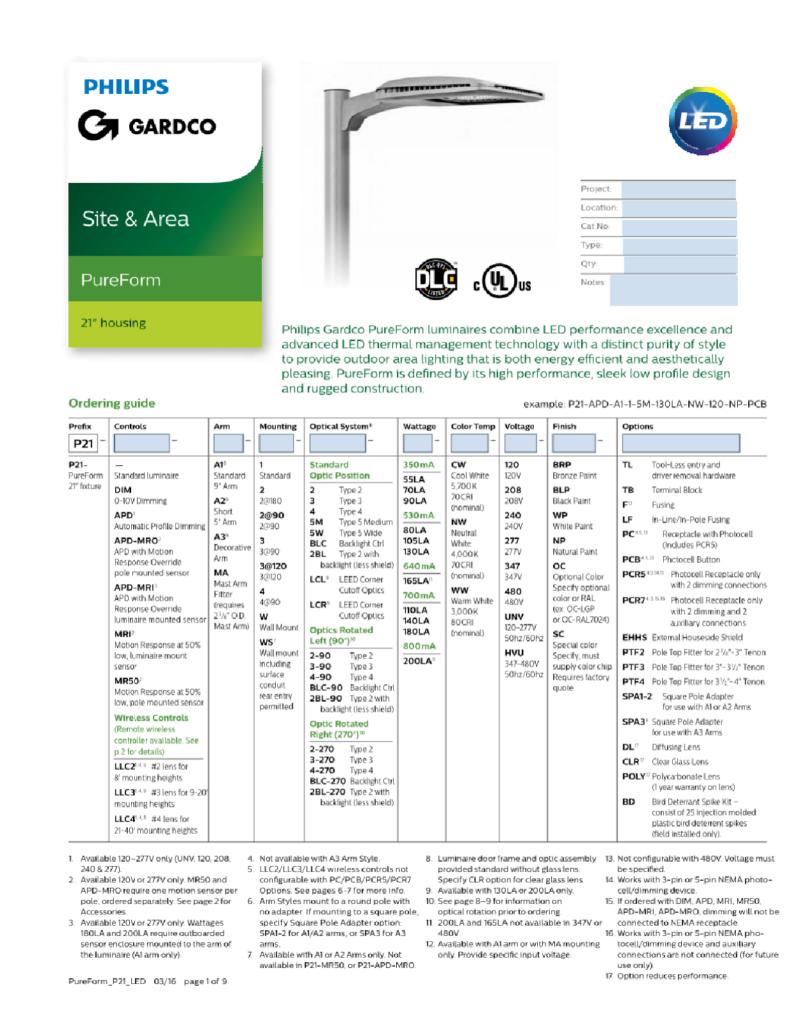
DEPARTMENT OF COMMUNITY DEVELOPMENT

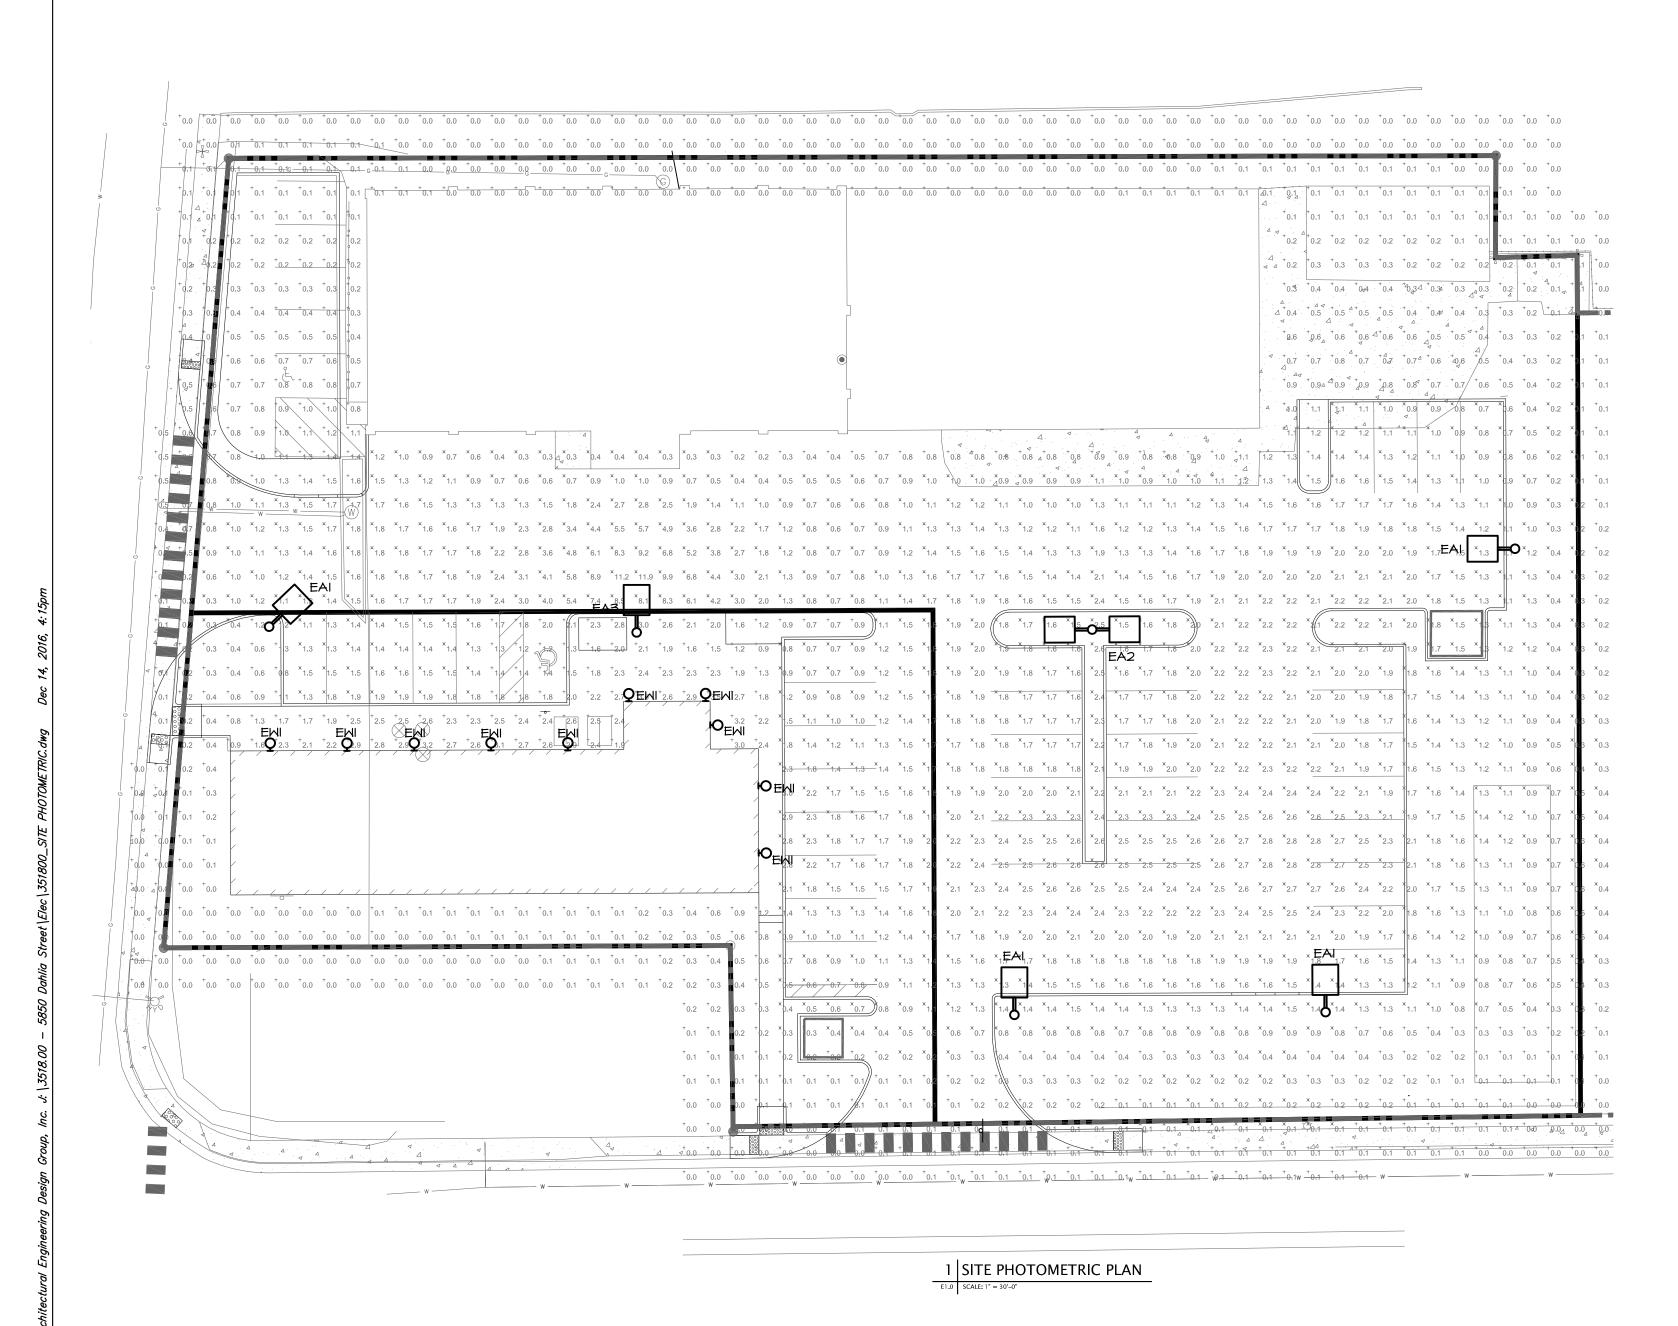

5850 DAHLIA ST., COMMERCE CITY, COLORADO A PORTION OF THE SOUTH HALF OF THE NORTHWEST QUARTER OF THE SOUTHEAST

QUARTER OF SECTION 7, TOWNSHIP 3, RANGE 67 WEST OF THE 6TH P.M., CITY OF COMMERCE CITY, COUNTY OF ADAMS, STATE OF COLORADO





SP0212 REV A LED WAREHOUSE SHADE COLLECTION: The Old Dixie WHB17-PC-LED Standard Finish for ALL WHB13-PC-LED 100-Black 1250 LED Mounting is: Same as Accessories is: WHB15-PC-LED fixture // Leave Code Same as fixture // 2000 LED WHB17-PC-LED Leave Code Blank G- Goose Neck Color Temp 2700K Warm White 975- Galvanized СВК 100-Black 4000K Cool White Black Canopy color: 400-Barn Red **100-** Black 975-Galvanized colors, see color ^Specify stem model For additional Stem and Gooseneck: Gooseneck: 100- Black colors, see color ^Specify gooseneck model 200- White 975- Galvanized For additional mounting 980- Brushed For additional glass options and details, see Aluminum options, see guard For additional colors, see color chart ORDER SPECIFICS ¹ Suitable for Damp locations. Standard length 8 feet. ² Suitable for Dry locations Only (Not CSA listed). Standard length 6 feet. *Additional lengths available on Cord & Stem

All design drawings and written material the written consent of Architectural

PARCEL IDENTIFICATION NUMBER: 182307400059

CITY STAFF CERTIFICATE

APPROVED BY THE DEPARTMENT OF COMMUNITY DEVELOPMENT OF

THE CITY OF COMMERCE CITY, THIS DAY OF

DEPARTMENT OF COMMUNITY DEVELOPMENT