


DEVELOPMENT PLAN

GROENDYKE TRANSPORT FACILITY

LOT 1, BLOCK 1, MARTY FARMS SUBDIVISION, FILING NO. 5 COMMERCE CITY, COUNTY OF ADAMS, STATE OF COLORADO

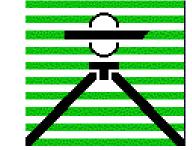

DREXEL, BARRELL & CO. Engineers • Surveyors 1800 38th STREET BOULDER, CO 80301 CONTACT: KEITH E. HENSEL, P.E. 303.442.4338 BOULDER • COLORADO SPRINGS

DEVELOPMENT PLAN NOTES

IN THE INTEREST OF COMPATIBILITY OF SURROUNDING LAND USES, ILLUMINATION OF ANY KIND ON PRIVATE PROPERTY SHALL BE DIRECTED AND CONTROLLED IN SUCH A MANNER SO THAT THERE SHALL BE NO DIRECT RAYS OF LIGHT WHICH EXTEND BEYOND THE BOUNDARIES OF THE PROPERTY FROM WHICH IT ORIGINATES.

TRASH ENCLOSURE NOTE

TRASH ENCLOSURES SHALL BE CONSTRUCTED TO A MINIMUM HEIGHT OF SIX (6) FEET AND OF THE SAME COMPLIMENTARY MATERIAL AND COLOR AS THE MAIN BUILDING.

ROOF MOUNTED ELECTRICAL AND MECHANICAL EQUIPMENT SHALL BE PLACED OR SCREENED SUCH THAT THE EQUIPMENT IS NOT VISIBLE FROM ANY POINT. SUCH EQUIPMENT SHALL BE SCREENED WITH THE SAME MATERIALS AND COLORS AS THE MAIN BUILDING.

SIGNAGE NOTE

APPROVAL OF A SIGN PERMIT IS REQUIRED IN ADDITION TO DEVELOPMENT PLAN APPROVAL. SIGN LOCATIONS SHOWN ON THE DEVELOPMENT PLAN WILL BE REVIEWED FOR POSSIBLE CONFLICTS WITH SIGHT TRIANGLES AND EASEMENTS. HOWEVER. THESE SIGNS WILL NOT BE APPROVED BY THE DEVELOPMENT PLAN. ALL SIGNS MUST CONFORM TO THE CITY OF COMMERCE CITY'S SIGN CODE.

FENCING NOTE

APPROVAL OF A FENCE PERMIT IS REQUIRED IN ADDITION TO DEVELOPMENT PLAN APPROVAL. ALL FENCES MUST CONFORM TO THE CITY OF COMMERCE CITY'S FENCING REQUIREMENTS.

DOWNSPOUT NOTE

NO ROOF DOWNSPOUT OUTFALLS WILL BE ALLOWED TO DRAIN OVER SIDEWALKS, BIKE PATHS, OR ANY OTHER PEDESTRIAN ROUTES.

AMERICANS WITH DISABILITIES NOTE

THE APPLICANT HAS THE OBLIGATION TO COMPLY WITH ALL APPLICABLE REQUIREMENTS OF THE AMERICANS WITH DISABILITIES ACT. APPROVAL OF THIS DEVELOMENT PLAN DOES NOT CONSTITUTE COMPLIANCE WITH THIS ACT.

CONSTRUCTION NOTE

THE APPROVAL OF THIS DEVELOPMENT PLAN DOES NOT CONSTITUTE FINAL APPROVAL OF GRADING, DRAINAGE, UTILITY, PUBLIC IMPROVEMENTS, AND BUILDING PLANS. THESE PLANS MUST BE REVIEWED AND APPROVED BY THE APPROPRIATE AGENCY PRIOR TO THE ISSUANCE OF BUILDING PERMITS.

UNDERGROUND UTILITY NOTE

ALL OVERHEAD UTILITIES SERVING THIS SITE MUST BE PLACED UNDERGROUND PER LAND DEVELOPMENT CODE.

PROJECT SITE MAP



APPROVAL REQUESTED VIA CU-104-14

BASED ON THE MARTY FARMS INDUSTRIAL CENTER PUD AMENDMENT NO.1

- FAR MINIMUM TO BE REDUCED FROM 0.15 TO 0.05
- INCREASE MAXIMUM FRONT SETBACK FROM 80' TO 135'.

DEVELOPMENT PLAN SHEET LIST

SHEET

SHEET TITLE

COVER SHEET CVR SITE PLAN C 1.0 - C 1.1 C 2.0 - C 2.1 **GRADING PLAN UTILITY PLAN** C 3.0 - C 3.1 LT 1.0 - LT 1.1 LIGHTING PLAN LANDSCAPE PLAN L1-L3 **BUILDING ELEVATIONS** A 1.0 - A 1.2 C 4.0 **DETAILS**

PROJECT CONTACTS

CIVIL ENGINEER

1800 38th STREET

(303) 442-4338

Drexel, Barrell & Co.

BOULDER, COLORADO 80301

CONTACT: KEITH HENSEL, P.E.

LANDSCAPE ARCHITECT

Site Design, llc

P.O. 51 LOVELAND, CO 80539

CONTACT: TIM BRIGGS, ASLA,

South Adams Fire

Protection District

COMMERCE CITY, CO 80022

City of Commerce -

COMMERCE CITY, CO 80022

CONTACT: RACHELLE URSO

8602 ROSEMARY STREET

6550 E. 72nd AVENUE

(303) 288-0835

Public Works

(303) 289-8171

STORM SEWER

(970) 271-9169

FIRE DEPARTMENT

APPLICANT

Groendyke Transport 9751 E. 104th AVENUE HENDERSON, CO 80640-8813 (303) 289-3373

CONTACT: LEE BOULDIN

SURVEYOR

Drexel, Barrell & Co.

1800 38th STREET BOULDER, COLORADO 80301 (303) 442-4338

CONTACT: MATT SELDERS, P.L.S.

BUILDING ARCHITECT

Schultz Squared Architects, LLC 1999 NORTH AMIDON, SUITE 373 WICHITA, KS 67203 (316) 253-8579 CONTACT: COREY SCHULTZ

CITY PLANNER

City of Commerce -Planning Department 7887 E. 60TH STREET COMMERCE CITY, CO 80022 (303) 277-8774 CONTACT: PAUL WORKMAN

WATER & SANITARY SEWER

South Adams County Water & Sanitation District 10200 E. 102nd AVENUE HENDERSON, COLORADO 80022 (720) 206-0595CONTACT: STEVEN VOEHRINGER

SITE DATA

MINIMUM PARKING

LOT ACREAGE GROSS LOT AREA RIGHT OF WAY DEDICATIONS NET LOT AREA BUILDING AREA 20,484 SF **BUILDING AREA** 960 SF FUELING PAD 21,444 SF TOTAL COVERED AREA NET LANDSCAPE AREA LANDSCAPE TREATMENT AREA 169,455 SF SQ. FT. ACRES % OF LOT LOT COVERAGE PROPOSED BUILDING 0.49 RECYCLED MATERIAL 160,704 3.69 CONCRETE/ASPHALT PAVEMENT 165,672 3.80 32.00% 32.77% 100% 517,275 11.875 TOTAL SITE AREA AREA USED BY VEHICLES OVER* 15,000 GVW 262,689 6.03 50.78% * INCLUDES SHORT TERM TRUCK PARKING, DRIVE ISLES, RECYCLED MATERIAL AREA AND THE TRUCK MANEUVERING AREA AROUND THE BUILDING.

1 SPACE/250 SF INDOOR SPACE 82 SPACES MAXIMUM PARKING 150 PERCENT OF MINIMUM PARKING 123 SPACES PROVIDED PARKING STANDARD (9'x19)117 SPACES HANDICAP (9'x19 w AISLE) 5 SPACES 122 SPACES TOTAL BICYCLE PARKING 1 SPACE/20 MOTOR VEHICLE SPACES 6 SPACES

BUILDING INFORMATION BUILDING OCCUPANCY INDUSTRIAL/TRUCK TRANSPORT BUILDING CONSTRUCTION TILT UP CONCRETE

MARTY FARMS LLP LAND OWNER 0172121102011 PARCEL IDENTIFICATION NUMBER (PIN) ZONING (EXISTING AND PROPOSED) MARTY FARMS PUD (I-3) SETBACKS MINIMUM FRONT

20 FEET 80 FEET MAXIMUM FRONT MINIMUM SIDE YARD 25 FEET MINIMUM REAR 20 FEET **EMPLOYEES** APPROXIMATE NUMBER OF EMPLOYEES 76

FLOOR AREA RATIO BUILDING AREA (COVERED AREA) SITE AREA (LESS DETENTION POND) PROPOSED FAR


21,444 SF 418,430 SF

CITY STAFF CERTIFICATE


APPROVED BY THE DEPARTMENT OF COMMUNITY DEVELOPMENT OF THE CITY OF

COMMERCE CITY, THIS _____ DAY OF _____,A.D._

DEPARTMENT OF COMMUNITY DEVELOPMENT SIGNATURE

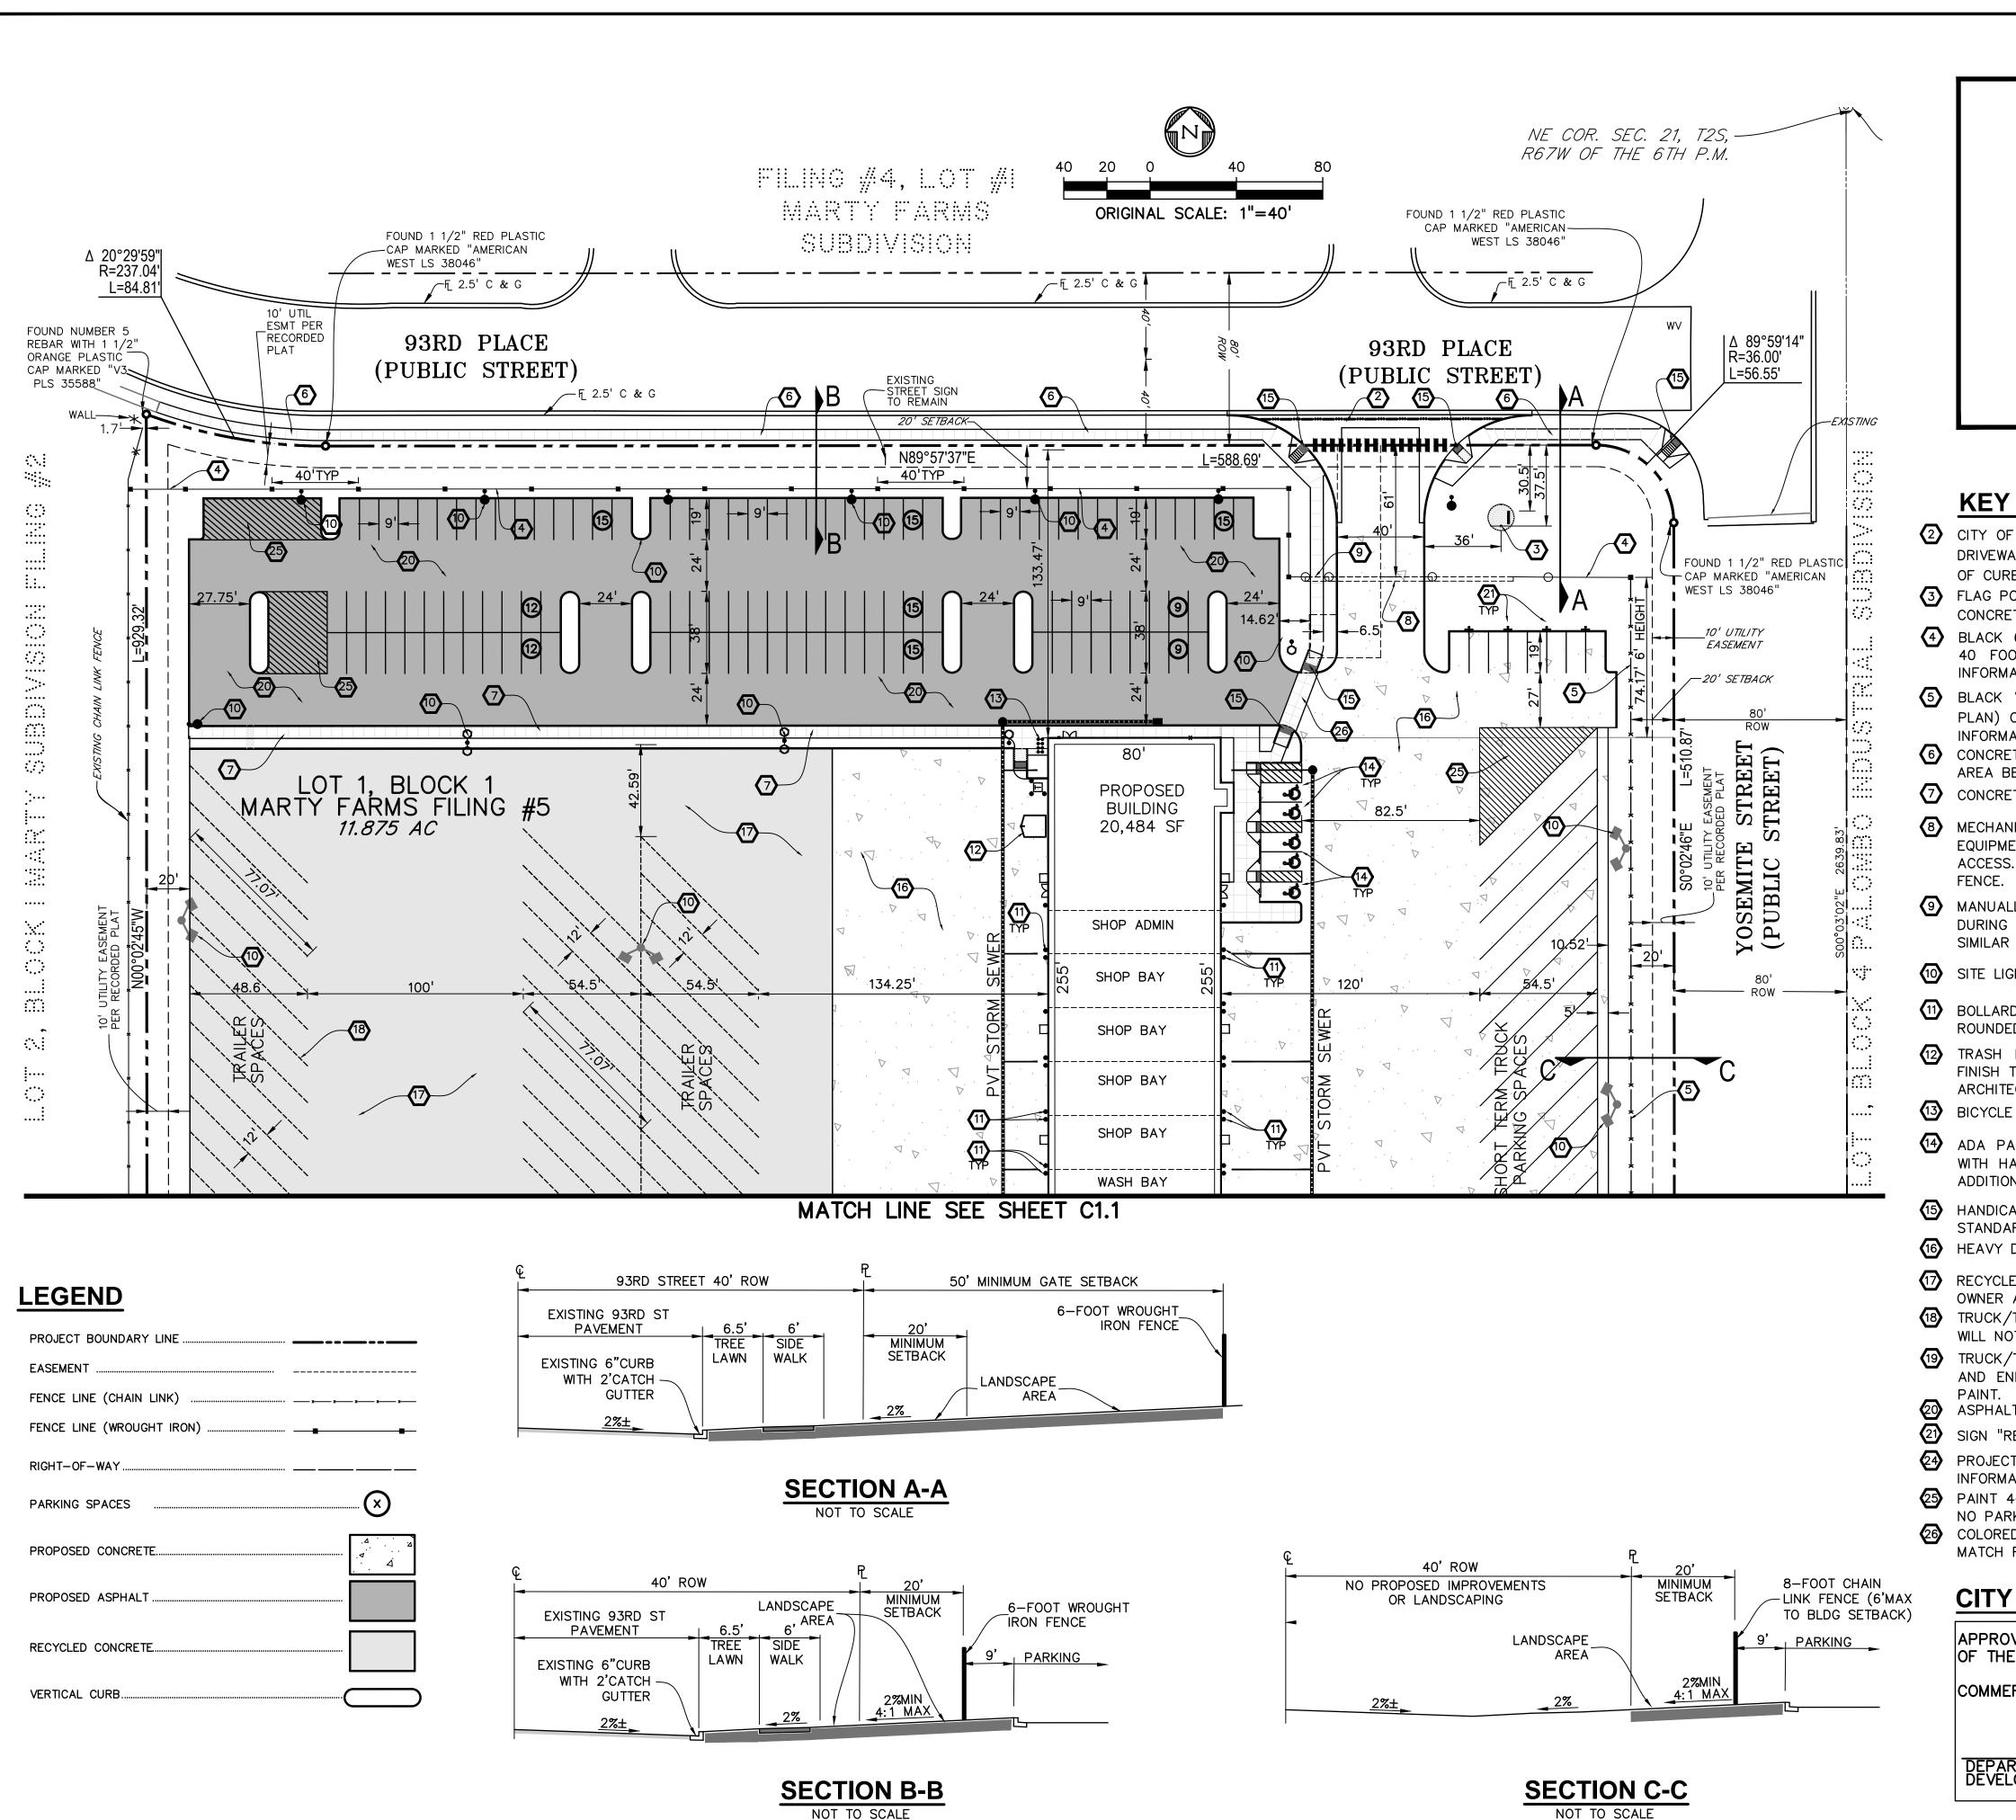

NOT TO SCALE

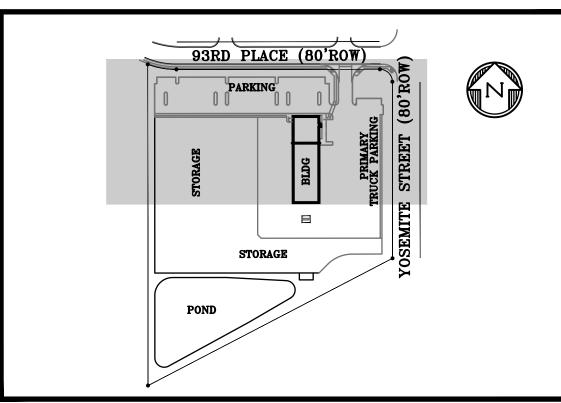

KEY MAP NOT TO SCALE

KEY NOTES

- 2 CITY OF COMMERCE CITY 8' WIDE CROSS PAN WITH CURBED APRONS. DRIVEWAY WIDTH TO BE 40' WIDE FLOW LINE OF CURB TO FLOW LINE OF CURB. RADIUS TO BE 40'.
- FLAG POLE, 20 FEET HIGH WITH 12-FOOT DIAMETER
- CONCRETE/CRUSHER FINES/PAVER PAD. MAXIMUM FLAG SIZE 3'x5'. 4 BLACK 6 FOOT HIGH WROUGHT IRON FENCE WITH MASONRY COLUMN 40 FOOT ON CENTER. REFER TO DETAIL SHEET FOR ADDITIONAL
- 5 BLACK VINYL OR POWER COATED 8 FOOT HIGH (OR AS NOTED ON PLAN) CHAIN LINK FENCE. REFER TO DETAIL SHEET FOR ADDITIONAL
- 6 CONCRETE SIDEWALK 6-FEET WIDE WITH 6.5-FOOT WIDE TREE LAWN AREA BEHIND STREET FLOW LINE.
- CONCRETE SIDEWALK 6-FEET WIDE (6-FEET WIDE ALONG BUILDING).
- 8 MECHANICALLY OPERATED 40' (TOTAL WIDTH) GATE. GATE TO HAVE EQUIPMENT AS SPECIFIED BY THE FIRE DEPARTMENT FOR EMERGENCY
- (9) MANUALLY OPERATED 6' MAN GATE. GATE TO REMAIN UNLOCKED DURING BUSINESS HOURS FOR ADA ACCESS. GATE SHALL BE OF SIMILAR MATERIALS AND DESIGN AS FENCE.
- SITE LIGHT POLE. REFER TO SITE LIGHTING PLAN.
- BOLLARD, MINIMUM 4-INCH STEEL PIPE FILLED WITH CONCRETE, ROUNDED TOP, PAINTED TRAFFIC YELLOW.
- TRASH ENCLOSURE, CONCRETE BLOCK CONSTRUCTION, SAC RUBBED FINISH TO MATCH BUILDING, GATE TO BE SOLID. REFER TO DETAIL ON ARCHITECTURAL SHEET.
- BICYCLE PARKING, MINIMUM 6 SPACES ON 3 INVERTED "U".
- 4 ADA PARKING SPACES, 9x19 WITH 8' OR 5' STRIPED ACCESS AISLE WITH HANDICAP RAMP, AND SIGNAGE. REFER TO DETAIL SHEET FOR ADDITIONAL INFORMATION.
- (15) HANDICAP RAMP IN ACCORDANCE WITH CITY OF COMMERCE CITY STANDARDS AND DETAILS.
- 16 HEAVY DUTY CONCRETE SURFACE.
- RECYCLED CONCRETE SURFACE. TO BE MAINTAINED BY THE PROPERTY OWNER AT A MINIMUM DEPTH OF 4-INCHES.
- TRUCK/TRAILER PARKING LOCATION ON RECYCLED MATERIAL. SPACE WILL NOT BE STRIPED.
- TRUCK/TRAILER PARKING LOCATION ON CONCRETE SURFACE. SPACES AND END CAPS TO BE STRIPED WITH 4-INCH WIDE YELLOW TRAFFIC
- ASPHALT PARKING SURFACE.
- SIGN "RESERVED FOR GROENDYKE COMPANY VEHICLES.
- PROJECT IDENTIFICATION SIGN, REFER TO DETAILS FOR ADDITIONAL INFORMATION.
- PAINT 4-INCH DIAGONAL STRIPS AT 2-FOOT ON CENTER DESIGNATING NO PARKING AREAS.
- COLORED CONCRETE CROSSWALK WITH SCORING. BUFF COLORED TO MATCH RAMPS.

CITY STAFF CERTIFICATE

APPROVED BY THE DEPARTMENT OF COMMUNITY DEVELOPMENT OF THE CITY OF
COMMERCE CITY, THIS DAY OF,A.D
DEPARTMENT OF COMMUNITY DEVELOPMENT SIGNATURE

PREPARED BY:
DREXEL, BARRELL & C
Engineers • Surveyors 1800 38th STREET
BOULDER, CO 80301 CONTACT: KEITH E. HENSEL, P. 303 442 4338

APPLICANT:

BOULDER • COLORADO SPRINGS

GRAND JUNCTION



GROENDYKE TRANSPORT, INC.
COMMERCE CITY COLORADO (303) 289-3373 CONTACT: LEE BOULDIN

OENT


ISSUE	DATE
DEVELOPMENT PLAN	12/6/13
DESIGNED BY:	KEH
DRAWN BY:	JPF
CHECKED BY:	KEH
FILE NAME: 206	08-00SP01


DRAWING SCALE: HORIZONTAL: 1" = 40' VERTICAL: 1'' = 40'

SITE PLAN

PROJECT NO. 20608-00BLCV

SHEET: 2 OF 16

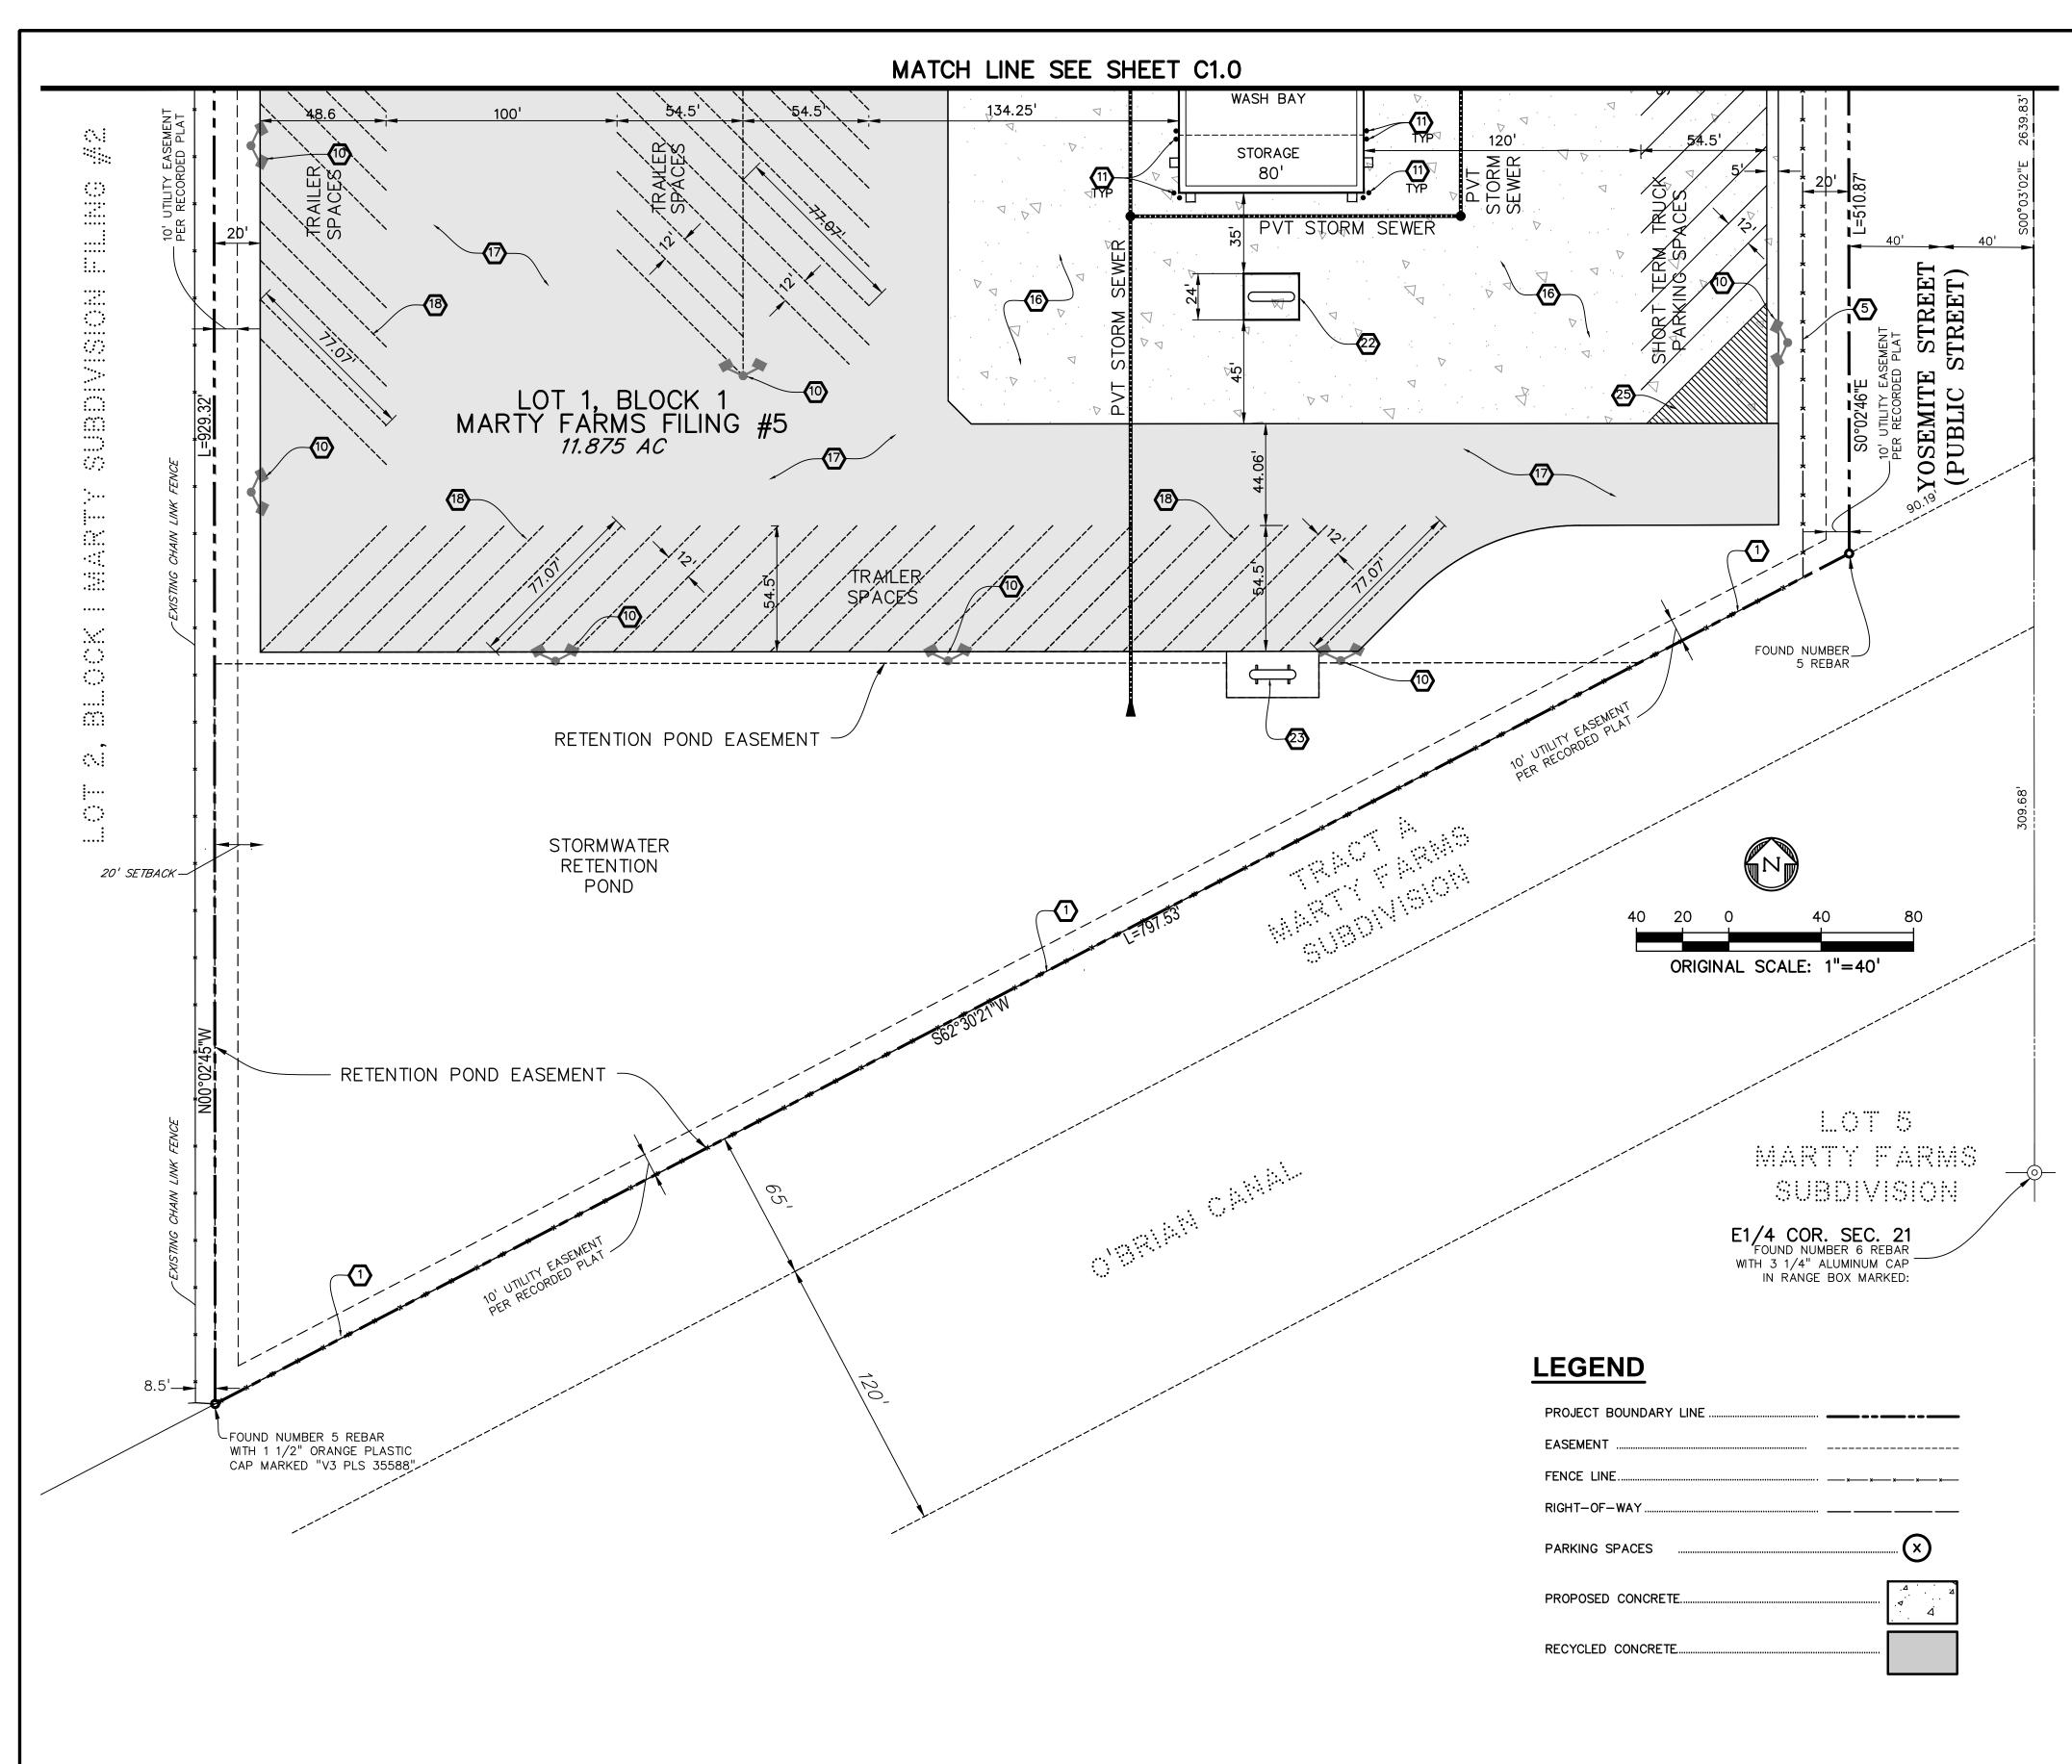

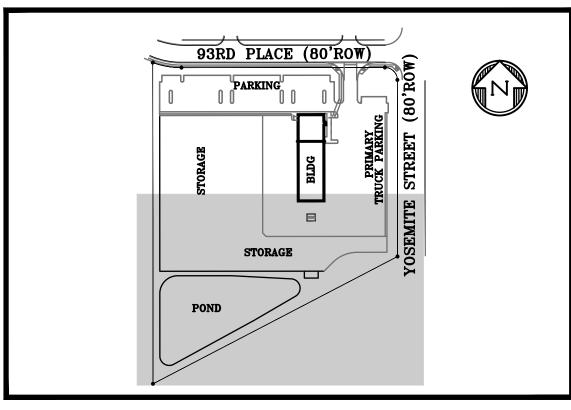

KEY MAP NOT TO SCALE

GENERAL NOTES

- 1. THE PROJECT IS LOCATED WITHIN THE MARTY FARMS SUBDIVISION AND IS OWNED BY MARTY FARMS LLLP.
- 2. THE PARCEL IDENTIFICATION NUMBER (PIN) FOR THE PROJECT SITE IS: 0172121102011.
- 3. PROJECT SITE IS LOCATED WITH THE MARTY FARMS PUP (I-3) ZONE.
- 4. THE BENCHMARK UTILIZED FOR THIS MAP IS A NGS BENCHMARK, DESIGNATION OF 5090, PID KK0395, LOCATED AT THE INTERSECTION OF EAST 96TH AVENUE AND THE UNION PACIFIC RAILROAD, WITH AN ELEVATION OF 5094.85 NAVD 88 DATUM.

KEY NOTES

- OPEN STYLE 8 FOOT HIGH WIRE FENCE TO MATCH ADJACENT PROPERTY. REFER TO DETAIL SHEET FOR ADDITIONAL INFORMATION.
- BLACK VINYL OR POWER COATED 8 FOOT HIGH CHAIN LINK FENCE.
 REFER TO DETAIL SHEET FOR ADDITIONAL INFORMATION.
- SITE LIGHT POLE. REFER TO SITE LIGHTING PLAN.
- BOLLARD, MINIMUM 4—INCH STEEL PIPE FILLED WITH CONCRETE, ROUNDED TOP, PAINTED TRAFFIC YELLOW.
- (6) HEAVY DUTY CONCRETE SURFACE.
- RECYCLED CONCRETE SURFACE. TO BE MAINTAINED BY THE PROPERTY OWNER AT A MINIMUM DEPTH OF 4—INCHES.
- TRUCK/TRAILER PARKING LOCATION ON RECYCLED MATERIAL. SPACE WILL NOT BE STRIPED.
- TRUCK/TRAILER PARKING LOCATION ON CONCRETE SURFACE. SPACES AND END CAPS TO BE STRIPED WITH 4—INCH WIDE YELLOW TRAFFIC PAINT.
- FUEL PUMPS WITH 24 X 40 CANOPY, REFER TO DETAILS FOR ADDITIONAL NFORMATION.
- 12,000 GALLON (MAXIMUM) FUEL STORAGE TANK, REFER TO ADDITIONAL DETAILS.
- PAINT 4-INCH DIAGONAL STRIPS AT 2-FOOT ON CENTER DESIGNATING NO PARKING AREAS.



1800 38th STREET
BOULDER, CO 80301

CONTACT: KEITH E. HENSEL, P.E.
303.442.4338

BOULDER • COLORADO SPRINGS
GRAND JUNCTION

APPLICANT:



GROENDYKE TRANSPORT, INC.

COMMERCE CITY

COLORADO

(303) 289-3373

CONTACT: LEE BOULDIN

AOENDYKE TRANSPORT, IN
LOT 1
LOT 1
LOT 1
COMMERCE CITY

ISSUE DATE

DEVELOPMENT PLAN 12/6/13

DESIGNED BY: KEH

DRAWN BY: JPF

CHECKED BY: KEH

FILE NAME: 20608-00SP01

DRAWING SCALE:
HORIZONTAL: 1" = 40'

VERTICAL: 1'' = 40'

SITE PLAN


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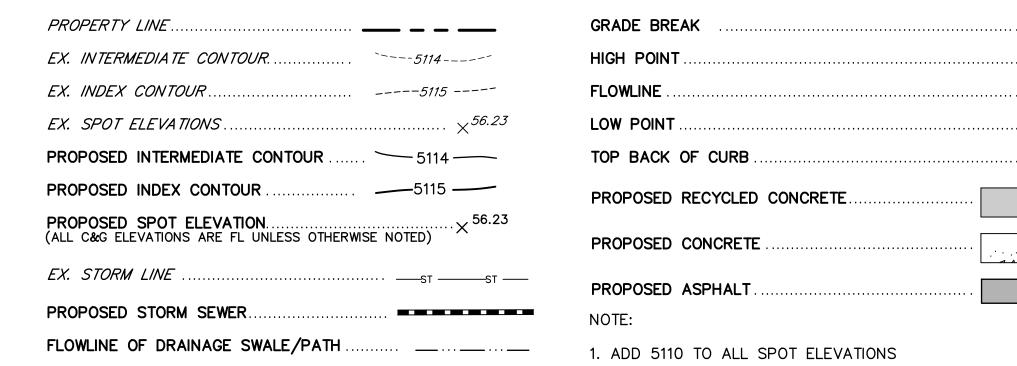
SHEET: 3 OF 16


CITY STAFF CERTIFICATE

APPROVED BY THE DEPARTMENT OF THE CITY OF	OF	COMMUNITY	DEVELOPMEN ³
COMMERCE CITY, THIS D	ΑY	OF	_,A.D
DEPARTMENT OF COMMUNITY DEVELOPMENT SIGNATURE			



LEGEND

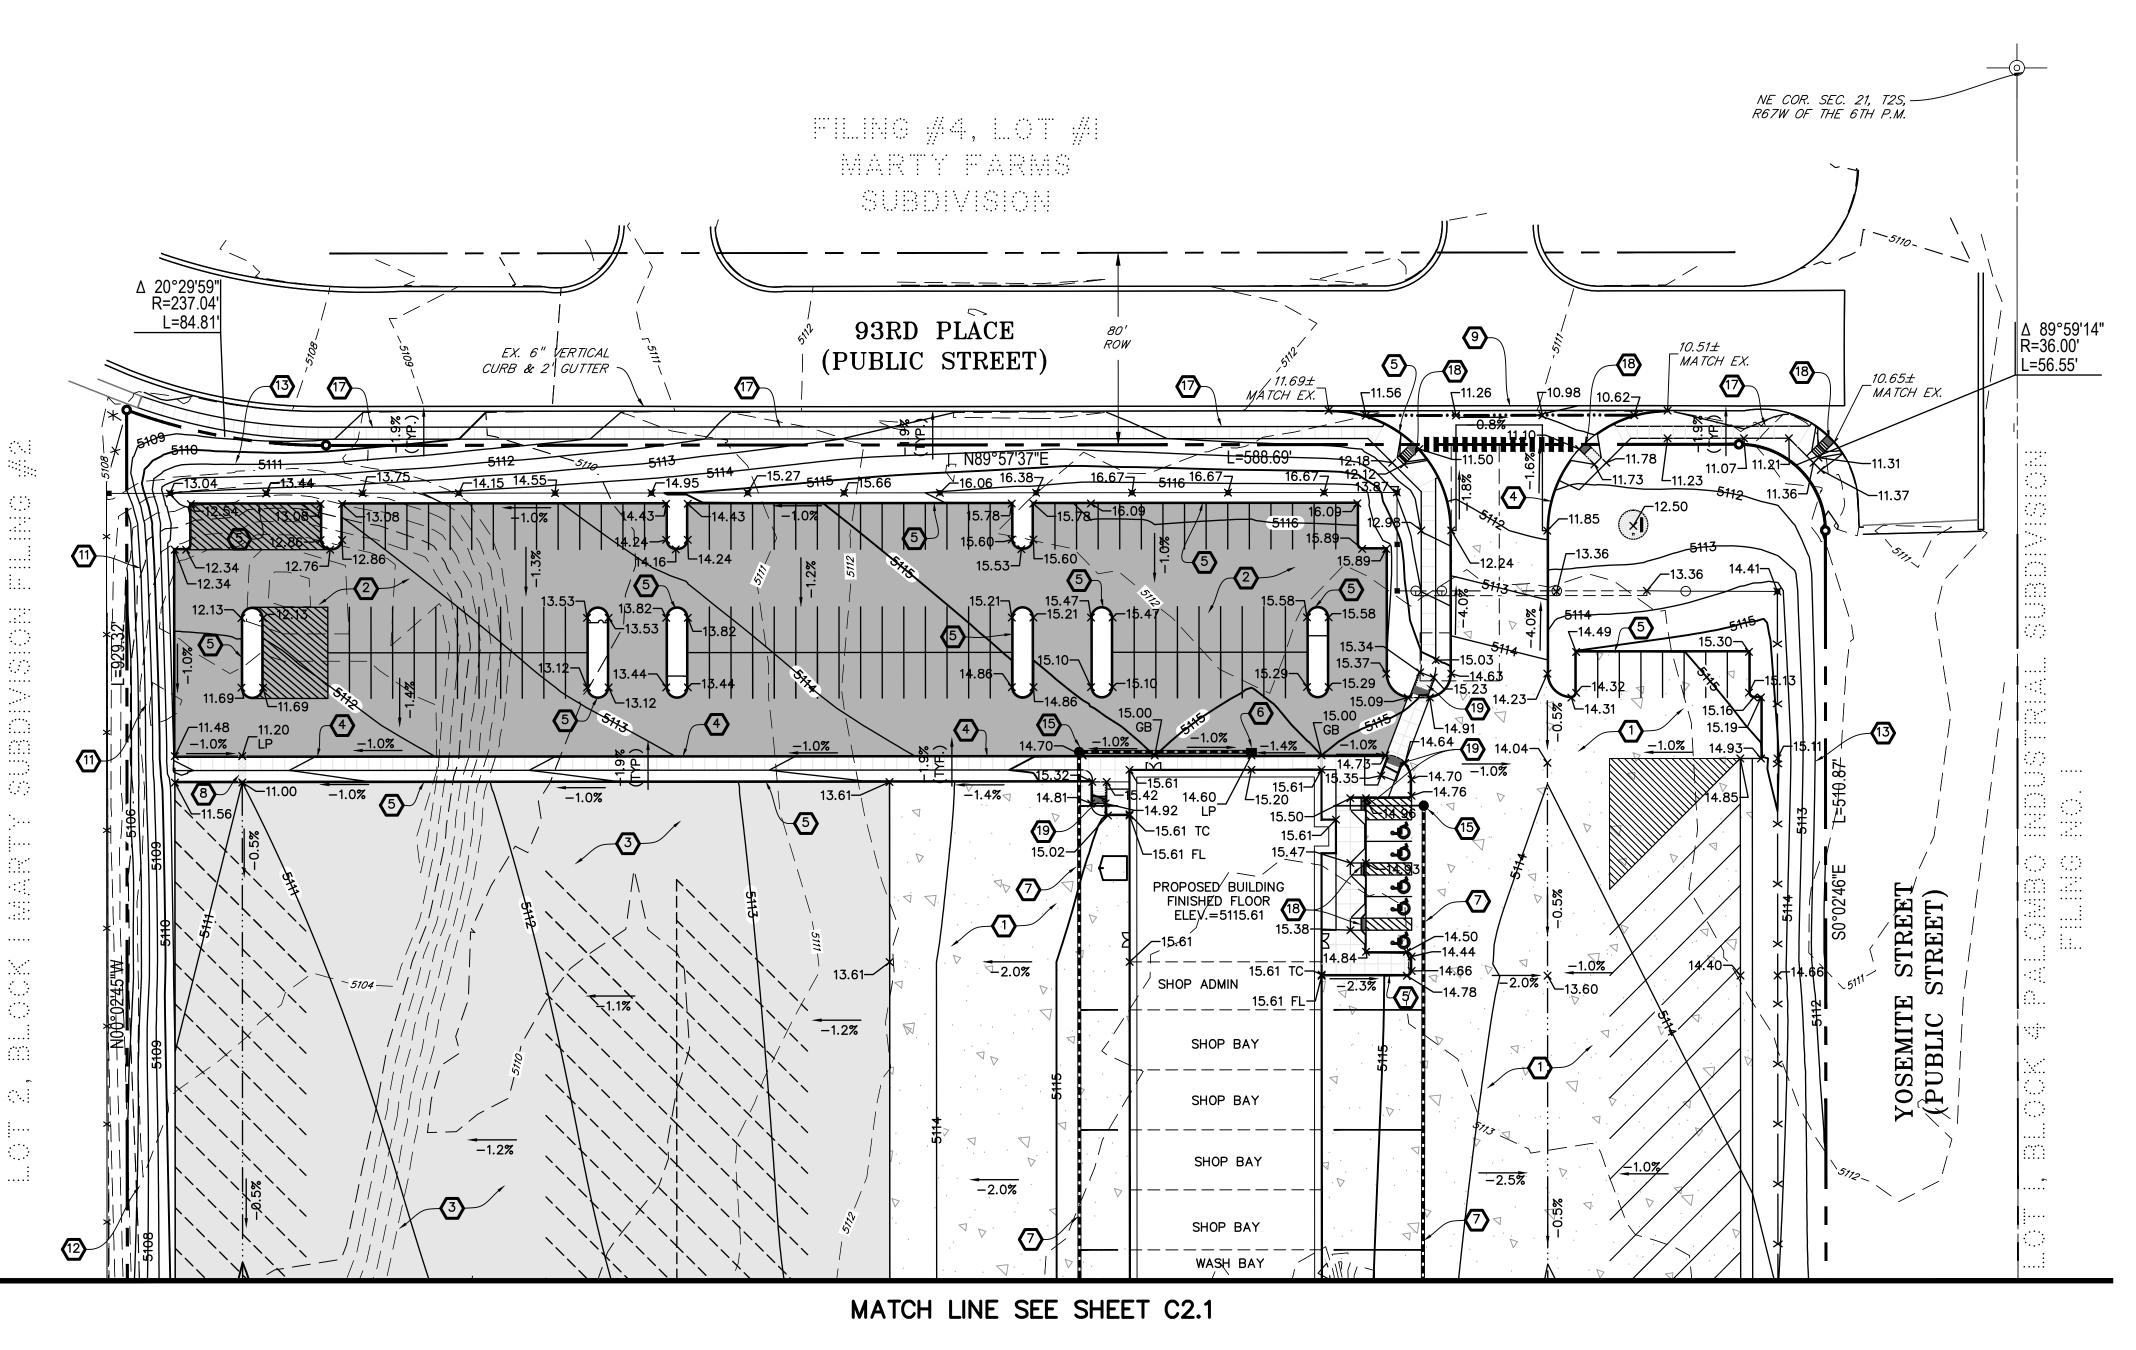

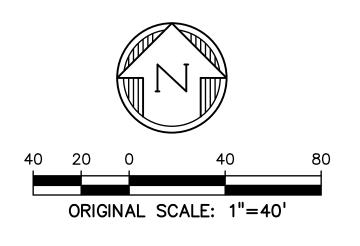




CALL UTILITY NOTIFICATION
CENTER OF COLORADO

811

CALL 3-BUSINESS DAYS IN ADVANCE
BEFORE YOU DIG, GRADE, OR EXCAVATE
FOR THE MARKING OF UNDERGROUND
MEMBER UTILITIES.

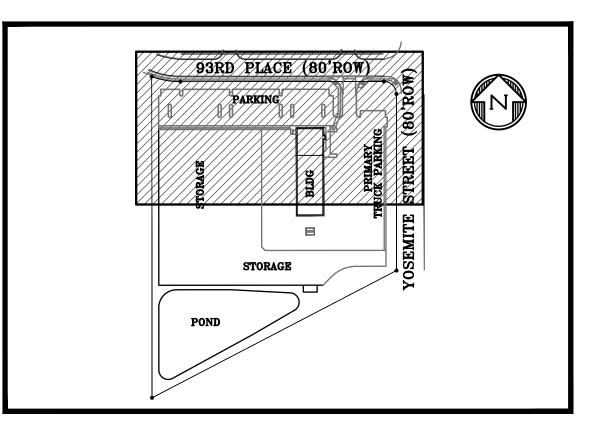

KEY MAP

GENERAL NOTES

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KEY NOTES

- CONCRETE PAVEMENT, THICKNESS TO BE DETERMINED BY THE SITE GEOTECHNICAL REPORT.
- ASPHALT PAVEMENT, THICKNESS TO BE DETERMINED BY THE SITE GEOTECHNICAL REPORT.
- RECYCLED CONCRETE WITH GEOTEXTILE FABRIC, THICKNESS TO BE DETERMINED BY THE SITE GEOTECHNICAL REPORT.
- SIX INCH HIGH CURB WITH CATCH PAN OR INTEGRAL WITH PAVEMENT.
- SIX INCH HIGH CURB WITH SPILL PAN OR INTEGRAL WITH PAVEMENT.
- TYPE 13 COMBINATION INLET LOCATED AT THE CURB
- 15-INCH PVC PRIVATE ROOF DRAIN COLLECTOR
- (8) CONSTRUCT 18-INCH WIDE SIDEWALK CHASE PER COMMERCE CITY STANDARD DETAIL 308-05.
- © CONSTRUCT 8-FOOT WIDE CONCRETE CROSSPAN PER COMMERCE CITY STANDARD DETAIL 308-04. .
- REINFORCED SLOPE TO PROTECT FROM SHEET FLOW EROSION.
- GRADE MAXIMUM 3 HORIZONTAL TO 1 VERTICAL SLOPE.
- GRADE MAXIMUM 4 HORIZONTAL TO 1 VERTICAL SLOPE.
- GRADE MAXIMUM 5 HORIZONTAL TO 1 VERTICAL SLOPE.
- GRADE POND BOTTOM LEVEL FOR BEST INFILTRATION.
- 15 INSTALL 4-FOOT DIAMETER STORM SEWER MANHOLE.
- (16) INSTALL FLARED END SECTION WITH TRASH RACK.
- CONSTRUCT 5-FOOT WIDE DETACHED CONCRETE SIDEWALK PER COMMERCE CITY STANDARD DETAIL 308-06.
- CONSTRUCT TYPE 3A STYLE PEDESTRIAN CURB RAMP PER COMMERCE CITY STANDARD DETAIL 308-03.
- CONSTRUCT TYPE 1 STYLE PEDESTRIAN CURB RAMP PER COMMERCE CITY STANDARD DETAIL 308-03.

CITY STAFF CERTIFICATE

APPROVED BY THE DEPARTMENT OF COMMUNITY DEVELOPMEN OF THE CITY OF
COMMERCE CITY, THIS DAY OF,A.D
DEPARTMENT OF COMMUNITY DEVELOPMENT SIGNATURE

PREPARED BY:

DREXEL, BARRELL & CO.
Engineers • Surveyors
1800 38th STREET
BOULDER, CO 80301
CONTACT: KEITH E. HENSEL, P.E.
303.442.4338
BOULDER • COLORADO SPRINGS
GRAND JUNCTION

APPLICANT:



GROENDYKE TRANSPORT, INC.

COMMERCE CITY

COLORADO

(303) 289-3373

CONTACT: LEE BOULDIN

COENDYKE TRANSPORT, IN

LOT 1

MARTY FARMS SUB. FILING NO. 5

COMMERCE CITY

ISSUE	DATE
DEVELOPMENT PLAN	12/6/13
DESIGNED BY:	CWK

DRAWN BY:

CHECKED BY:

FILE NAME: | 20608-00GR01

KEH

DRAWING SCALE:

HORIZONTAL: 1'' = 40'


VERTICAL: 1'' = 40'

GRADING PLAN

PROJECT NO. 20608-00BLCV

C2.0

SHEET: 4 OF 16

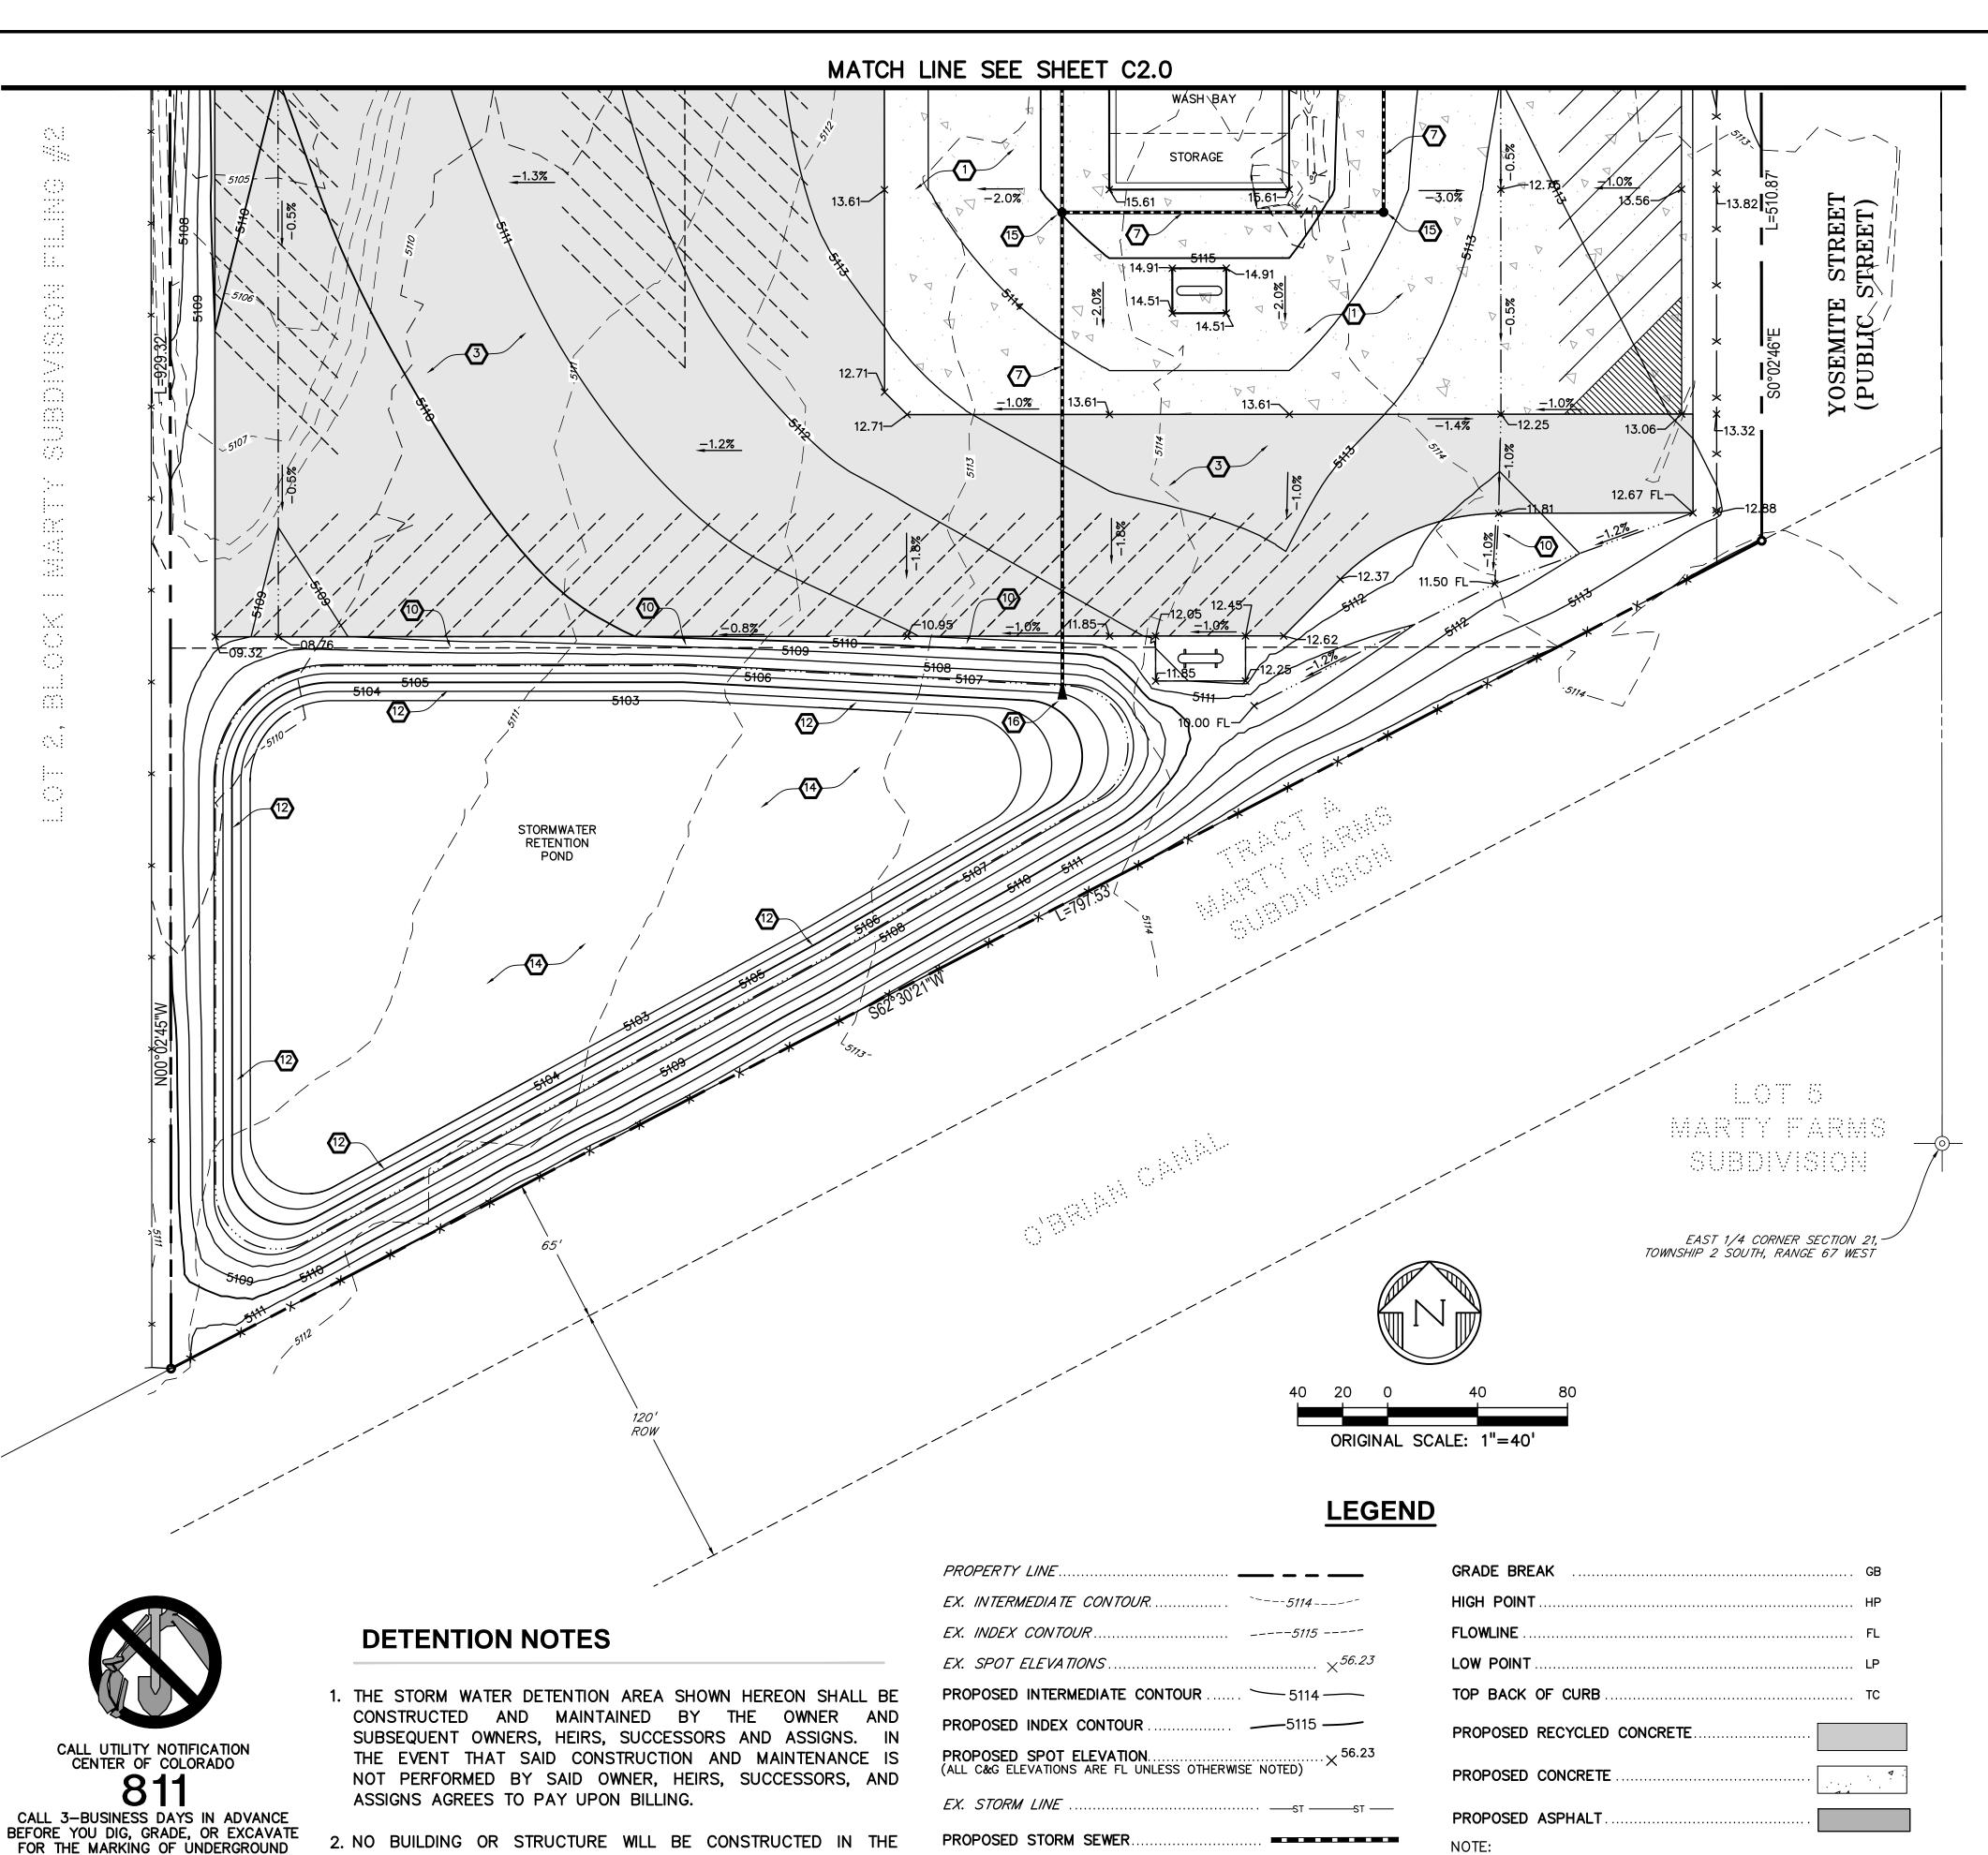

FLOWLINE OF DRAINAGE SWALE/PATH.


1. ADD 5110 TO ALL SPOT ELEVATIONS

DETENTION AREA AND NO CHANGES OR ALTERATIONS AFFECTING

THE HYDRAULIC CHARACTERISTICS OF THE DETENTION AREA

WILL BE MADE WITHOUT THE APPROVAL OF THE CITY.

MEMBER UTILITIES.

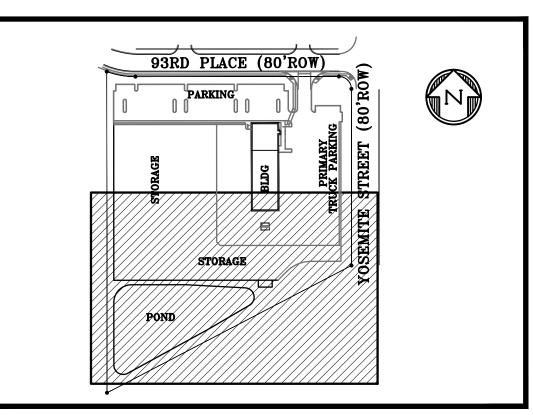

KEY MAP

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KEY NOTES

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CITY STAFF CERTIFICATE

APPROVED BY THE DEPARTMENT OF COMMUNITY DEVELOPMENTOF THE CITY OF
COMMERCE CITY, THIS DAY OF,A.D
DEPARTMENT OF COMMUNITY DEVELOPMENT SIGNATURE

Z'S

PREPARED BY:

DREXEL, BARRELL & CC Engineers • Surveyors 1800 38th STREET BOULDER, CO 80301 CONTACT: KEITH E. HENSEL, P.E. 303.442.4338 BOULDER • COLORADO SPRINGS

APPLICANT:

GRAND JUNCTION



GROENDYKE TRANSPORT, INC.

COMMERCE CITY

COLORADO

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CONTACT: LEE BOULDIN

DENDYKE TRANSPORT, IN

LOT 1

MARTY FARMS SUB. FILING NO. 5

COMMERCE CITY

ISSUE DATE
DEVELOPMENT PLAN 12/6/13

DESIGNED BY: CWK
DRAWN BY: CWK
CHECKED BY: KEH
FILE NAME: 20608-00GR01


DRAWING SCALE:
HORIZONTAL: 1" = 40'
VERTICAL: 1" = 40'

GRADING PLAN


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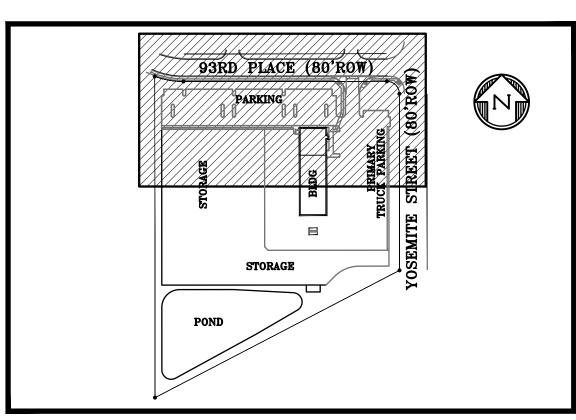
C2.1

SHEET: 5 OF 16

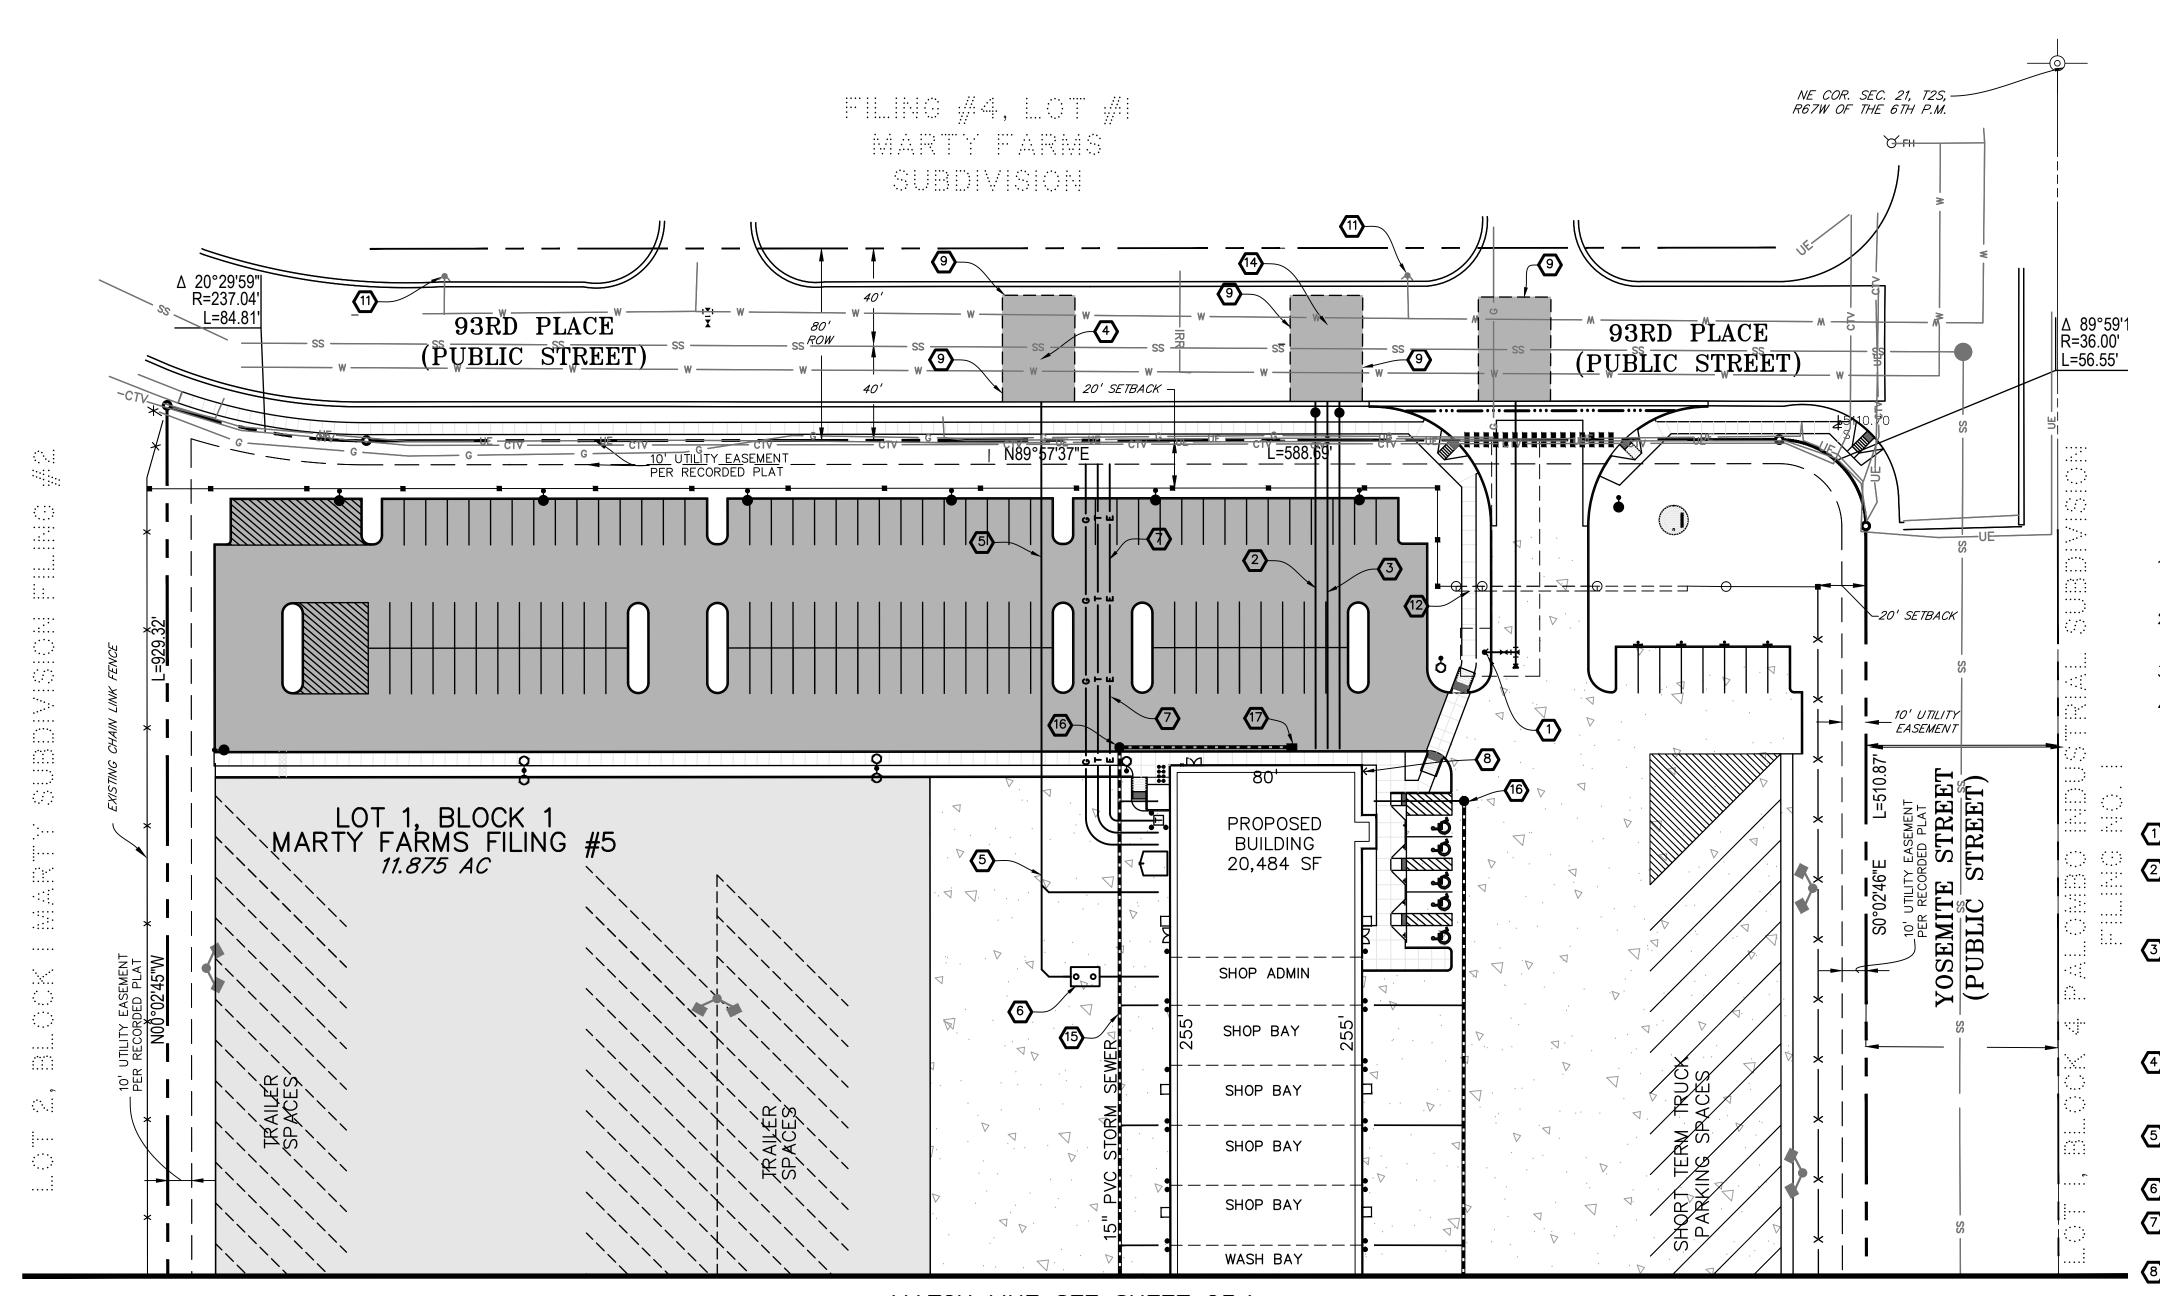

MATCH LINE SEE SHEET C3.1



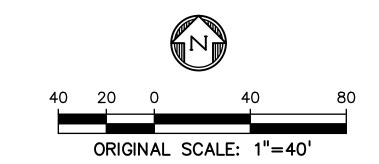

KEY MAP

NOT TO SCALE

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KEY NOTES

- PROPOSED FIRE HYDRANT WITH 20-FOOT EASEMENT.
- DOMESTIC SERVICE, $1\frac{1}{2}$ INCH CLASS 200 COPPER TUBE SERVICE WITH 5-FOOT DIAMETER METER PIT. IN ACCORDANCE WITH SOUTH ADAMS WATER AND SANITATION DISTRICT STANDARDS AND SPECIFICATIONS.
- IRRIGATION SERVICE, 1 INCH CLASS 200 COPPER TUBE SERVICE WITH 5-FOOT DIAMETER METER PIT. IN ACCORDANCE WITH SOUTH ADAMS WATER AND SANITATION DISTRICT STANDARDS AND SPECIFICATIONS. IRRIGATION SERVICE TO INCLUDE DOUBLE CHECK BACK FLOW PREVENTER.
- SANITARY SEWER SERVICE SADDLE TAP ON EXISTING SEWER MAIN. IN ACCORDANCE WITH ADAMS COUNTY WATER AND SANITATION DISTRICT STANDARDS AND SPECIFICATIONS.
- SANITARY SEWER SERVICE, 4—INCH PVC AT 2.0% MINIMUM SLOPE WITH CLEANOUTS AT MAXIMUM 100' SPACING.
- (6) APPROXIMATELY 800 GAL SAND/OIL SEPARATOR.
- DRY UTILITY CONDUITS, GAS, ELECTRICAL, TELEPHONE. EXACT BUILDING ENTRY LOCATION TO BE DETERMINED.
- 8 BUILDING FDC LOCATION.
- SAWCUT AND PATCH EXISTING ASPHALT IN ACCORDANCE WITH CITY OF COMMERCE CITY STANDARDS AND SPECIFICATIONS.
- EXISTING FIRE HYDRANT LOCATION.
- POWER/EQUIPMENT/CONTROLS FOR AUTOMATIC GATES.
- (3) CONDUIT FOR SITE LIGHTING.
- FIRE LINE, 6—INCH DUCTILE IRON PIPE, CUT IN 8"X8"X6" TEE WITH 8"
 MAIN LINE VALVE AND 6" FIRE SERVICE VALVE.
- 15" PVC PRIVATE STORM SEWER
- 16 INSTALL 4' DIAMETER STORM SEWER MANHOLE.
- TYPE 13 INLET ON CURB LINE.

CITY STAFF CERTIFICATE

APPROVED BY THE DEPARTMENT OF THE CITY OF	OF	COMMUNITY	DEVELOPMENT
COMMERCE CITY, THIS D)AY	OF	_,A.D
DEPARTMENT OF COMMUNITY DEVELOPMENT SIGNATURE			

PREPARED BY:

DREXEL, BARRELL & CO.
Engineers • Surveyors
1800 38th STREET
BOULDER, CO 80301
CONTACT: KEITH E. HENSEL, P.E.
303.442.4338
BOULDER • COLORADO SPRINGS
GRAND JUNCTION

APPLICANT:



GROENDYKE TRANSPORT, INC.

COMMERCE CITY

COLORADO

(303) 289-3373

CONTACT: LEE BOULDIN

COENDYKE TRANSPORT, IN

LOT 1

MARTY FARMS SUB. FILING NO. 5

COMMERCE CITY

COMMERCE CITY

ISSUE DATE
DEVELOPMENT PLAN 12/6/13

DESIGNED BY: KEH

DRAWN BY: JPF

CHECKED BY: KEH

FILE NAME: 20608-00UT01

DRAWING SCALE:

HORIZONTAL: 1" = 40'


VERTICAL: 1" = 40'


UTILITY PLAN

PROJECT NO. 20608-00BLCV

C3.0

SHEET: 6 OF 16

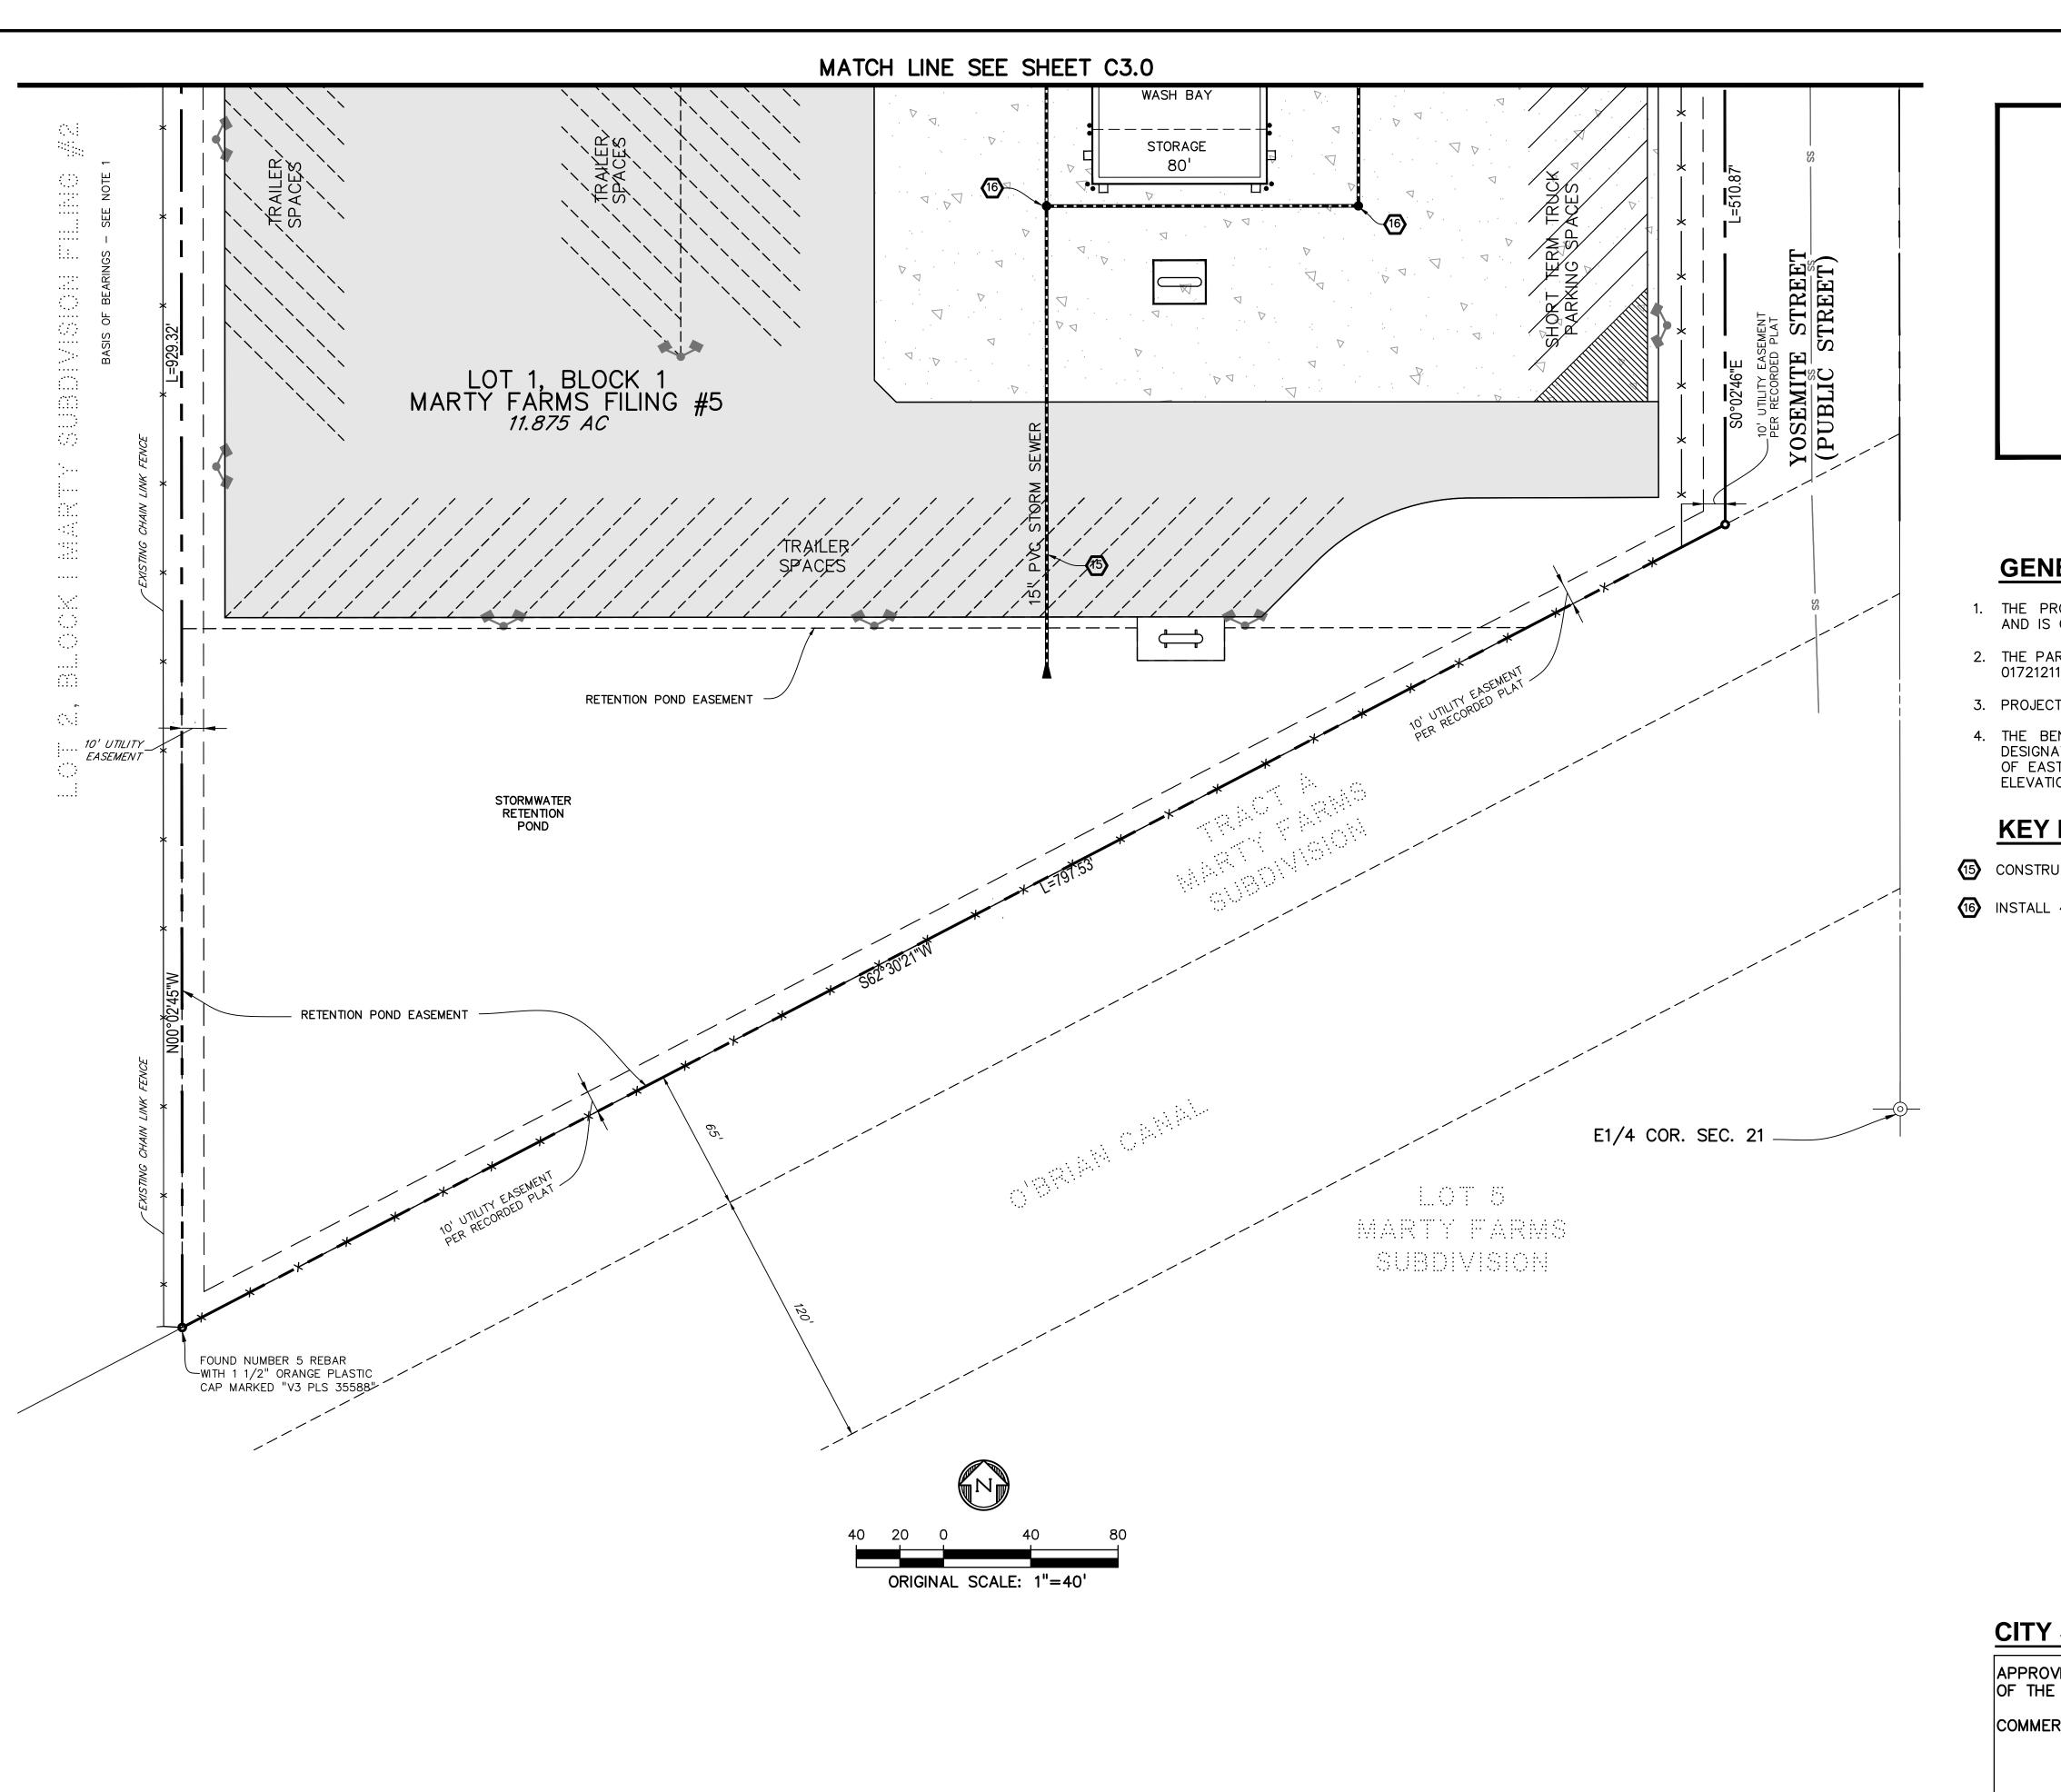

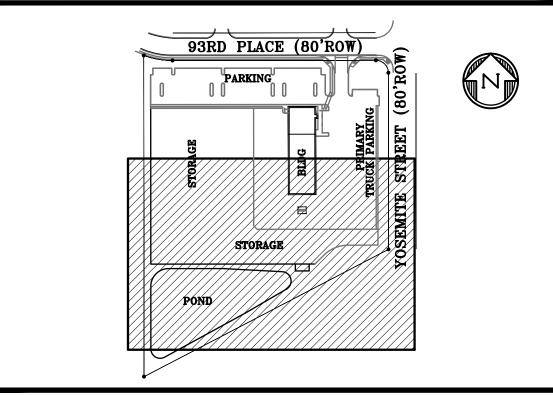

KEY MAP

NOT TO SCALE

GENERAL NOTES

- 1. THE PROJECT IS LOCATED WITHIN THE MARTY FARMS SUBDIVISION AND IS OWNED BY MARTY FARMS LLLP.
- 2. THE PARCEL IDENTIFICATION NUMBER (PIN) FOR THE PROJECT SITE IS: 0172121102011.
- 3. PROJECT SITE IS LOCATED WITH THE MARTY FARMS PUP (I-3) ZONE.
- 4. THE BENCHMARK UTILIZED FOR THIS MAP IS A NGS BENCHMARK, DESIGNATION OF 5090, PID KK0395, LOCATED AT THE INTERSECTION OF EAST 96TH AVENUE AND THE UNION PACIFIC RAILROAD, WITH AN ELEVATION OF 5094.85 NAVD 88 DATUM.

KEY NOTES

- (15) CONSTRUCT 15" STORM SEWER
- 16 INSTALL 4' DIAMETER STORM SEWER MANHOLE.

PREPARED BY:

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Engineers • Surveyors
1800 38th STREET
BOULDER, CO 80301
CONTACT: KEITH E. HENSEL, P.E.
303.442.4338
BOULDER • COLORADO SPRINGS
GRAND JUNCTION

APPLICANT:



GROENDYKE TRANSPORT, INC. COMMERCE CITY COLORADO (303) 289-3373 CONTACT: LEE BOULDIN

ADEVELOPMENT PLANS FOR:

AOENDYKE TRANSPORT, INC

LOT 1

MARTY FARMS SUB. FILING NO. 5

COMMERCE CITY

ADAMS COLLINY

ADAMS CO

ISSUE DATE
DEVELOPMENT PLAN 12/6/13

DESIGNED BY: KEH

DRAWN BY: JPF

CHECKED BY: KEH

FILE NAME: 20608-00UT01

DRAWING SCALE:

HORIZONTAL: 1" = 40'

VERTICAL: 1" = 40'

UTILITY PLAN

PROJECT NO. 20608-00BLCV

C3.1


SHEET: 7 OF 16

CITY STAFF CERTIFICATE

APPROVED BY THE DEPARTMENT OF COMMUNITY DEVELOPMENT OF THE CITY OF

COMMERCE CITY, THIS ______ DAY OF _____, A.D._____.

DEPARTMENT OF COMMUNITY DEVELOPMENT SIGNATURE

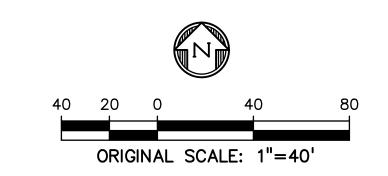

FILING #4, LOT #1
MARTY FARMS
SURDIVISION

PARKING

PARKING

PARKING

STORAGE

POND

POND

KEY MAP

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KEY NOTES

- LITHONIA FLOODLIGHTS, TYPE TFA 1000M RB
- MOUNTING HEIGHT NOT TO EXCEED 30 FEET WITH 3½' CONCRETE BASE.
- 3 LITHONIA MR2 400M SR4W LIGHT
- MOUNTING HEIGHT NOT TO EXCEED 25 FEET WITH 6" BASE.
- (5) LITHONIA MR2 400M SR4SC LIGHT

CITY STAFF CERTIFICATE

DEPARTMENT OF COMMUNITY DEVELOPMENT SIGNATURE

OF THE CITY OF

APPROVED BY THE DEPARTMENT OF COMMUNITY DEVELOPMENT

COMMERCE CITY, THIS _____ DAY OF _____,A.D.___

(6) LITHONIA KSF2 400M R4W LIGHT

PREPARED BY:

REXEL, BARRELL &
Engineers • Surveyor

DREXEL, BARRELL & C
Engineers • Surveyors
1800 38th STREET
BOULDER, CO 80301
CONTACT: KEITH E. HENSEL, F
303.442.4338
BOULDER • COLORADO SPRINGS
GRAND JUNCTION

APPLICANT:



GROENDYKE TRANSPORT, INCLOR MARTY FARMS SUB. FILING NO. 5
COMMERCE CITY

ISSUE DATE

DEVELOPMENT PLAN 12/6/13

DESIGNED BY: KEH

DRAWN BY: JPF

CHECKED BY: KEH

FILE NAME: 20608-00LGHT1

DRAWING SCALE:

HORIZONTAL: 1" = 40'

VERTICAL: 1" = 40'

LIGHTING PLAN

PROJECT NO. 20608-00BLCV


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SHEET: 8 OF 16

PROPOSED BUILDING 20,484 SF **侵**1 3.3 2.6 1.8 1.8 2.2 3.1 4.6 6.9 9.5 11.津収 0.2 5贳 6.0 6.0 6.0 6.0 6 **2**4 2.4 2.5 2.1 1.8 2.2 3.2 4.9 7.4 10.212.452 0.2 0.2 0.0 0.0 0.0 0.0 0.0 SHOP ADMIN 6.3 3.5 3.8 2.0 1.6 1.8 2.1 2.6 2.9 2.9 1.9 0.3 0.1 0.0 0.0 0.0 0.0 0.0 0.0 0.0 6.5 4.3 3.0 2.3 1.7 1.8 2.1 2.4 2.7 2.6 1.5 0.2 0.0 0.0 0.0 0.0 0.0 0.0 0.0 0.0 5.8 <u>3</u>.4 3.3 2.4 1.8 1.9 2.3 2.9 3.4 3.6 2.7 0.3 0.1 0.0 0.0 0.0 0.0 0.0 0.0 0.0) 0.0 0.0 0.0 0.0 0.0 0.1 0 1 1.3 2.8 2.9 2.6 2.2 1.8 1.5 1.3 1.4 1.7 2.5 4.3 6.5 9.2 9.5 8.6 6.1 4.1 2.8 2.0 1.5 1.4 2.1 3.1 3.1 3.1 5.8 SHOP BAY 8.9 3.9 3.6 2.5 1.9 2.2 2.9 3.9 5.2 6.3 6.1 1.1 0.1 1.0 0.0 0.0 0.0 0.0 0.0 0.0) 0.0 0.0 0.0 0.1 0.1 0 1 0.4 1.3 1.8 1.8 1.7 1.5 1.4 1.4 1.4 1.7 2.5 3.9 5.3 7.1 6.8 5.7 4.8 3.4 2.4 1.7 1.4 1.4 2.1 3.3 3.3 8.4 ------SHOP BAY 10.35.2 4.3 2.4 2.0 2.4 3.3 4.9 7.2 9.5 10.9 5 0.2 1.0 0.0 0.0 0.0 0.0 0.0 0.0) 0.0: 0.0 0.1 0.1 0.1 0.1 0.2 0.9 1.4 1.6 1.6 1.5 1.4 1.4 1.5 1.7 2.3 3.2 4.1 4.8 4.5 3.9 3.2 2.7 2.0 1.5 1.2 1.3 2.0 4.0 5.1 10.0 6.9 3.5 3.6 2.6 2.0 2.4 3.4 5.2 7.7 10.5 12.6 7.7 0.1 0.0 0.0 0.0 0.0 0.0 0.0 0.0) 0.0 0.1 0.1 0.1 0.1 0.1 0.3 1.2 1.8 1.9 1.8 1.6 1.5 1.5 1.5 1.7 2.0 2.5 3.0 3.3 3.1 2.8 2.3 2.0 1.7 1.4 1.2 1.2 2.1 3.3 3.3 6.9 SHOP BAY) 0.0 0.0 0.1 0.1 10.1 10.7 2.5 2.9 2.7 2.3 2.0 1.7 1.6 1.6 1.6 1.8 2.0 2.3 2.4 2.3 2.1 1.9 1.6 1.4 1.2 1.1 1.2 2.1 3.2 3.4 6.3) $\overset{\dagger}{0}$ 0 $\overset{\dagger}{0}$ 1 $\overset{\dagger}{0}$ 1 $\overset{\dagger}{0}$ 1 $\overset{\dagger}{0}$ 1 $\overset{\dagger}{0}$ 2 $\overset{\dagger}{1}$ 9 $\overset{\dagger}{5}$ 5 $\overset{\dagger}{5}$ 2 $\overset{\dagger}{4}$ 2 $\overset{\dagger}{3}$ 3 $\overset{\dagger}{2}$ 5 $\overset{\dagger}{5}$ 2 $\overset{\dagger}{4}$ 2 $\overset{\dagger}{3}$ 3 $\overset{\dagger}{5}$ 5 $\overset{\dagger}{5}$ 2 $\overset{\dagger}{5}$ 2 $\overset{\dagger}{5}$ 3 $\overset{\dagger}{5}$ 3 WASH BAY

MATCH LINE SEE SHEET LT 1.1

uminaire Schedule											
Symbol	Label	Quantity	Manufacturer	Catalog Number	Description	Lamp	Number Lamps	Filename	Lumens Per Lamp	Light Loss Factor	Wattage
*	А	23	Lithonia Lighting	TFA 1000M RB	SPECIFICATION FLOODLIGHT, RB DISTRIBUTIONS, 1000W MH, W/ CLEAR LAMP.	ONE 1000-WATT CLEAR ED-37 METAL HALIDE, VERTICAL BASE-DOWN POSITION.	1	TFA_1000M_RB.i es	110000	0.72	1080
Ç	В	2	Lithonia Lighting	MR2 400M SR4W (PULSE START)	Architectural Area Luminaire, 400W Metal Halide, SR4W Wide Reflector, Full Cutoff MEETS THE 'NIGHTTIME FRIENDLY' CRITERIA	ONE 400 WATT CLEAR ED28 PULSE START METAL HALIDE IN HORIZONTAL POSITION	1	MR2_400M_SR4 W_(PULSE_STAR T).ies	38000	0.72	456
Q	С	2	Lithonia Lighting	MR2 400M SR4W (PULSE START)	Architectural Area Luminaire, 400W Metal Halide, SR4W Wide Reflector, Full Cutoff MEETS THE 'NIGHTTIME FRIENDLY' CRITERIA	ONE 400 WATT CLEAR ED28 PULSE START METAL HALIDE IN HORIZONTAL POSITION	1	MR2_400M_SR4 W_(PULSE_STAR T).ies	38000	0.72	912
•	D	8	Lithonia Lighting	MR2 400M SR4SC (PULSE START)	Architectural Area Luminaire, 400W Metal Halide, SR4SC Sharp Cutoff Reflector, Full Cutoff MEETS THE 'NIGHTTIME FRIENDLY' CRITERIA	ONE 400 WATT CLEAR ED28 PULSE START METAL HALIDE IN HORIZONTAL POSITION	1	MR2_400M_SR4S C_(PULSE_START).ies	38000	0.72	456
	E	10	Lithonia Lighting	KSF2 400M R4W	Specification Area Luminaire, 400W Metal Halide, R4 Wide Reflector, Full Cutoff MEETS THE 'NIGHTTIME FRIENDLY' CRITERIA	ONE 400 WATT CLEAR ED28 PULSE START METAL HALIDE IN HORIZONTAL POSITION	1	KSF2_400M_R4W .ies	38000	0.72	456

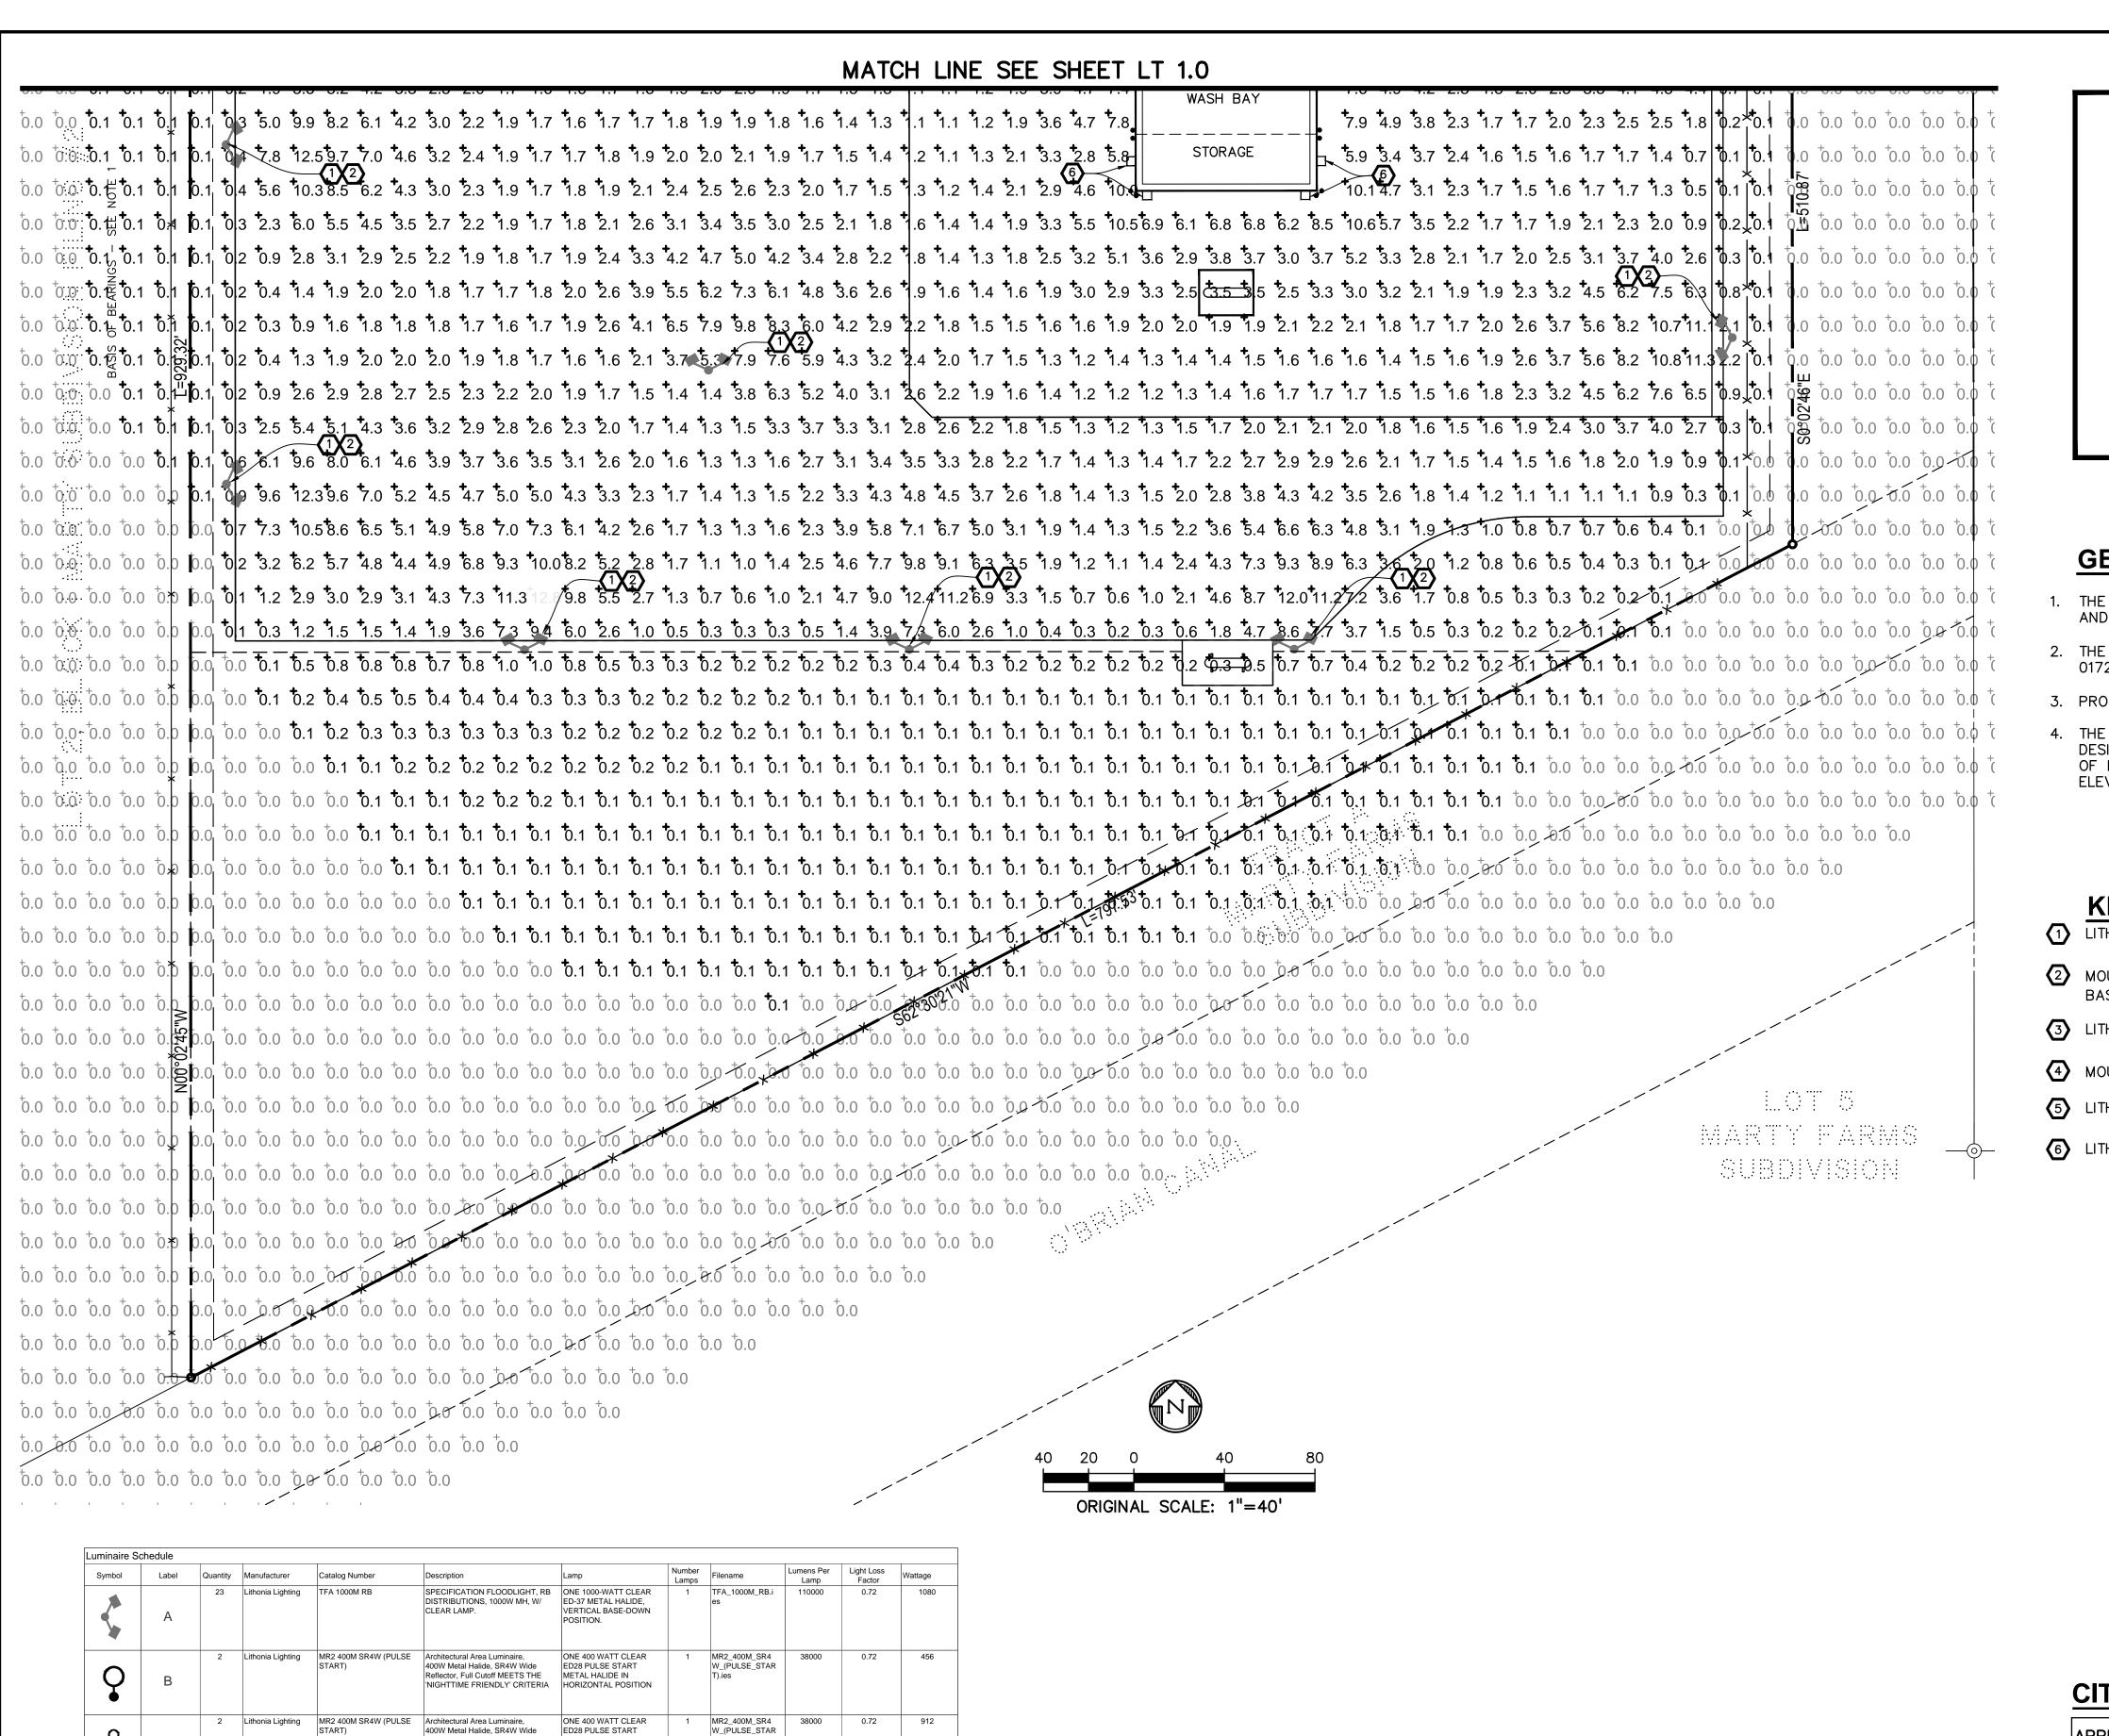

W_(PULSE_STAR

MR2 400M SR4S

C (PULSE START

0.72 456

ED28 PULSE START

METAL HALIDE IN HORIZONTAL POSITION

ED28 PULSE START

METAL HALIDE IN

'NIGHTTIME FRIENDLY' CRITERIA HORIZONTAL POSITION

400W Metal Halide, SR4SC Sharp ED28 PULSE START

'NIGHTTIME FRIENDLY' CRITERIA HORIZONTAL POSITION

Reflector, Full Cutoff MEETS THE


Cutoff Reflector, Full Cutoff MEETS THE 'NIGHTTIME

400W Metal Halide, R4 Wide

Reflector, Full Cutoff MEETS THE

8 Lithonia Lighting MR2 400M SR4SC (PULSE Architectural Area Luminaire,

10 Lithonia Lighting KSF2 400M R4W

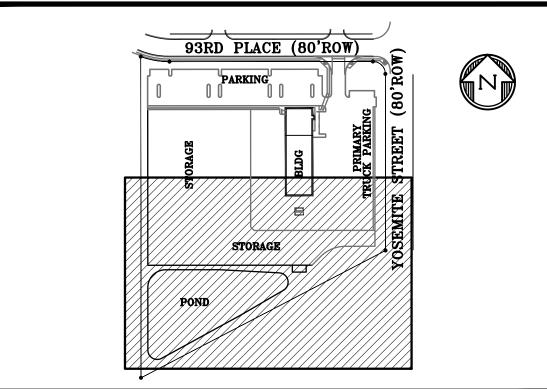

KEY MAP

GENERAL NOTES

- THE PROJECT IS LOCATED WITHIN THE MARTY FARMS SUBDIVISION

- OF EAST 96TH AVENUE AND THE UNION PACIFIC RAILROAD, WITH AN ELEVATION OF 5094.85 NAVD 88 DATUM

KEY NOTES

- LITHONIA FLOODLIGHTS, TYPE TFA 1000M RB
- MOUNTING HEIGHT NOT TO EXCEED 30 FEET WITH 3½' CONCRETE
- 3 LITHONIA MR2 400M SR4W LIGHT
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- 6 LITHONIA KSF2 400M R4W LIGHT



1800 38th STREET BOULDER, CO 80301 CONTACT: KEITH E. HENSEL, P.E 303.442.4338 BOULDER • COLORADO SPRINGS GRAND JUNCTION

APPLICANT:



GROENDYKE TRANSPORT, INC. COMMERCE CITY COLORADO (303) 289-3373 CONTACT: LEE BOULDIN

NS]

DATE **ISSUE** DEVELOPMENT PLAN 12/6/13

DESIGNED BY: DRAWN BY: CHECKED BY:

FILE NAME: 20608-00LGHT1

DRAWING SCALE: HORIZONTAL: 1'' = 40'VERTICAL: 1'' = 40'

LIGHTING PLAN


PROJECT NO. 20608-00BLCV

SHEET: 9 OF 16

CITY STAFF CERTIFICATE

APPROVED BY THE DEPARTMENT OF COMMUNITY DEVELOPMENT OF THE CITY OF COMMERCE CITY, THIS _____ DAY OF _____,A.D.__

DEPARTMENT OF COMMUNITY DEVELOPMENT SIGNATURE

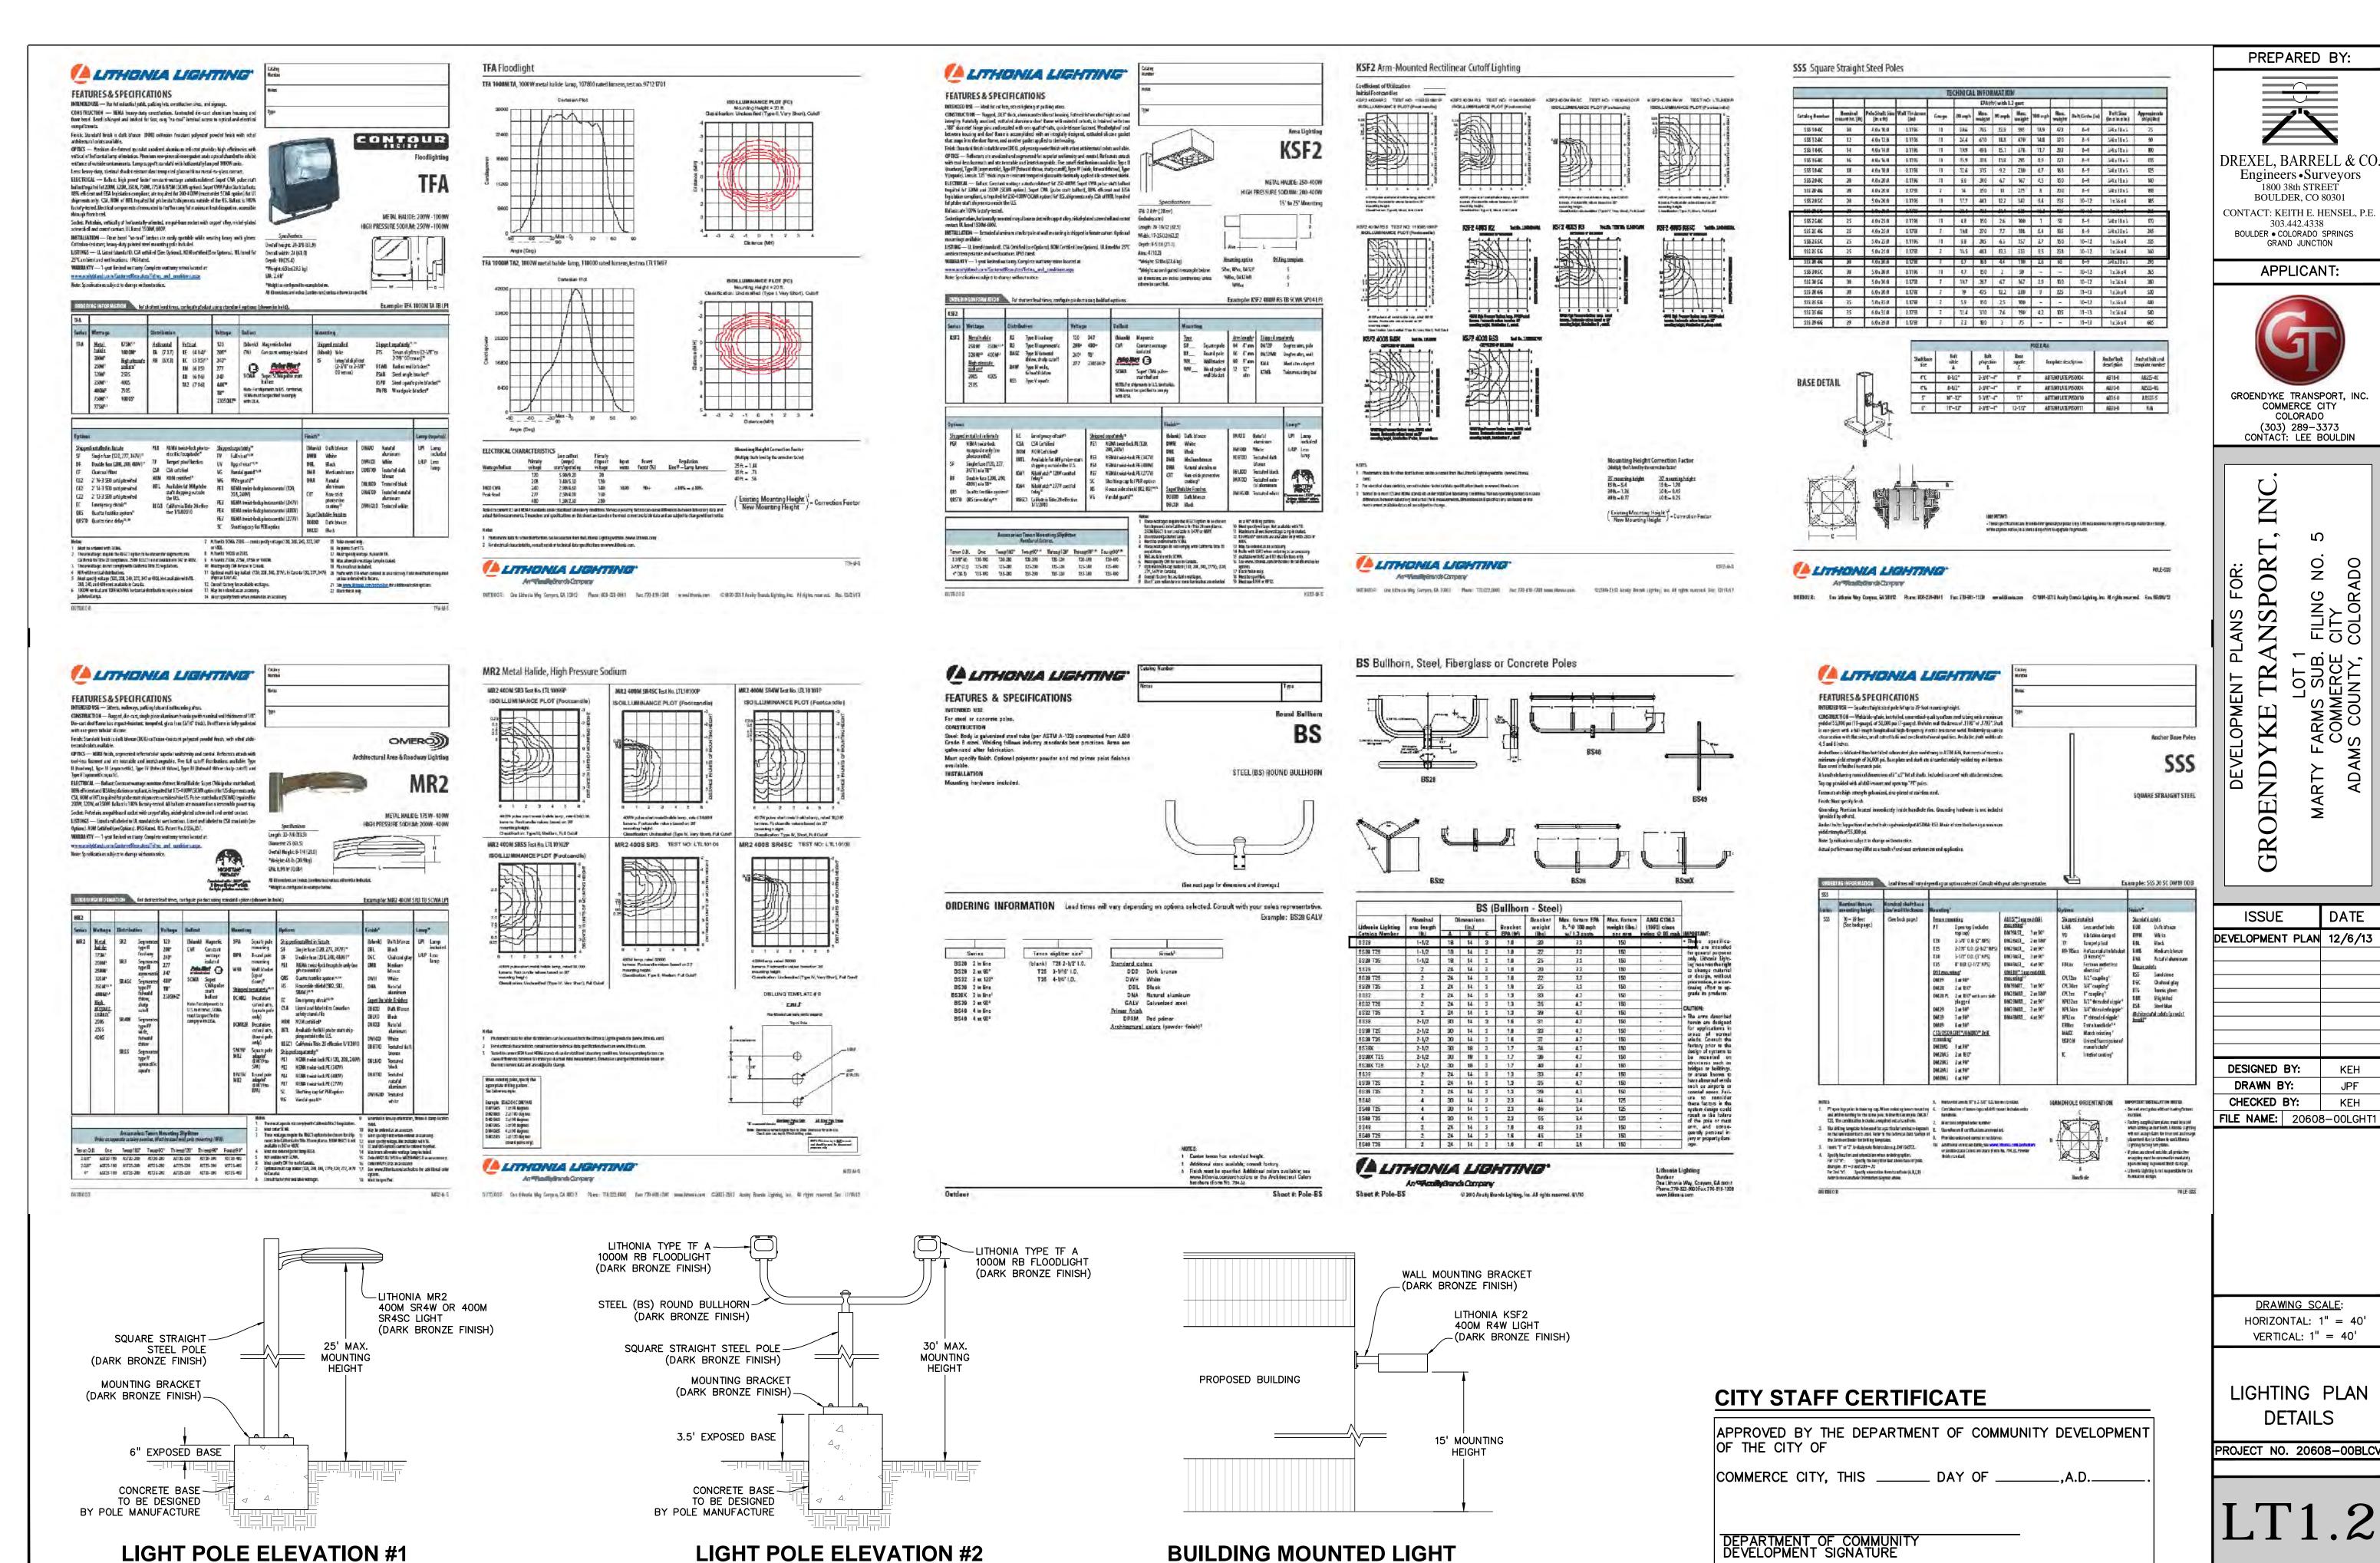


DREXEL, BARRELL & CO CONTACT: KEITH E. HENSEL, P.E

SHEET: 10 OF 16

LANDSCAPE AREAS

NOT TO SCALE

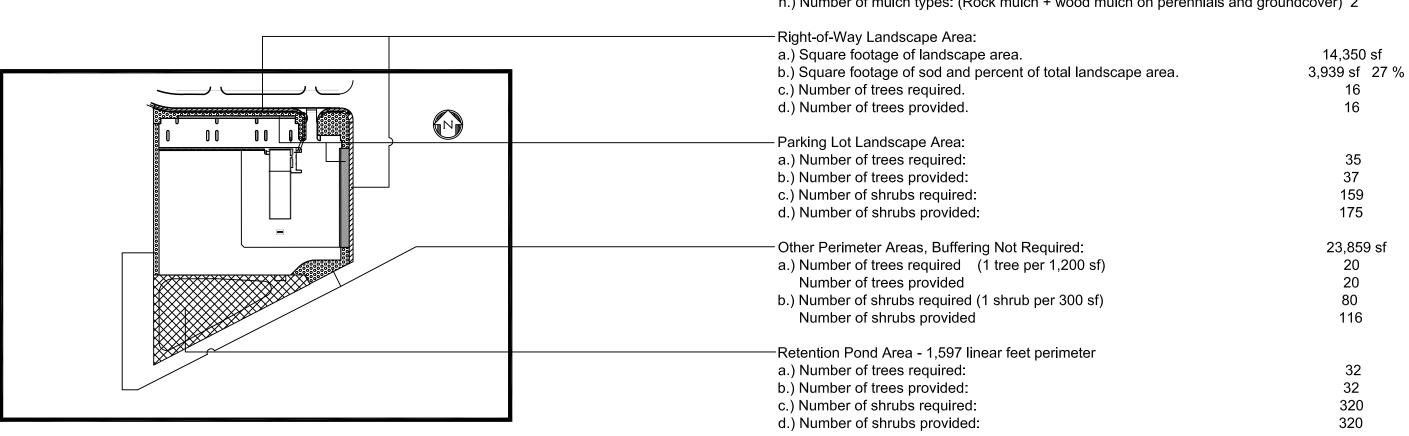

LANDSCAPE NOTES

1. SOIL PREPARATION - ALL PLANTED AREAS (EXCEPT NATIVE SEEDING) SHALL BE AMENDED WITH 5 CUBIC YARDS OF COMPOST PER 1000 SQUARE FEET. THESE AREAS SHALL BE RIPPED AND ROTOTILLED TO A DEPTH OF 6-8". RESTORE SOIL TO ORIGINAL GRADE AS SHOWN ON THE GRADING PLAN AFTER SOIL PREPARATION IS COMPLETED.

2. SOD - ALL AREAS DESIGNATED AS TURF SHALL BE SODDED WITH DROUGHT TOLERANT KENTUCKY BLUEGRASS BLEND SOD. TURF AREAS SHALL BE FINE GRADED BEFORE SOD IS INSTALLED.

3. EDGING - ALL PLANTING BEDS SHALL BE EDGED WITH ROLLED TOP STEEL EDGING. EDGING SHALL BE HELD IN PLACE WITH STEEL PINS INSTALLED APPROXIMATELY 3' APART.

4. SEEDING - SEEDED AREAS SHALL BE TILLED OR SCARIFIED TO LOOSEN THE

5. WEED BARRIER - ALL SHRUB BEDS & GRAVEL AREAS SHALL RECEIVE DEWITT PRO-5 WEED BARRIER FABRIC OR APPROVED EQUIVALENT INSTALLED UNDER GRAVEL. OVERLAP SEAMS A MINIMUM OF 6". AT OVERLAP LOCATIONS AND EDGES OF CURBS, WALLS, STRUCTURES, PAVEMENTS, AND EDGING, WEED BARRIER SHALL BE SECURED WITH 11-GAUGE, 6-INCH LONG STAPLES AT 18 INCHES O.C. AT ALL EDGES.

6. TREE RINGS - ALL TREES IN LAWN AND SEEDED AREAS SHALL HAVE A 4-FOOT DIAMETER RING OF 4" DEEP SHREDDED REDWOOD MULCH OVER WEED BARRIER FABRIC.

7. ROCK MULCH - ALL SHRUB BEDS AND GRAVEL AREAS SHALL RECEIVE A 4" LAYER OF 1 1/2" TAN RIVER ROCK MULCH.

8. BARK MULCH - PERENNIAL AND GROUNDCOVER PLANTS SHALL RECEIVE 4" OF SHREDDED REDWOOD MULCH, AND NO WEED BARRIER FABRIC.

9. ANY SUBSTITUTE PLANT MATERIAL OR LANDSCAPE MATERIAL MUST BE APPROVED BY THE LANDSCAPE ARCHITECT OR THE OWNER'S REPRESENTATIVE. ALL PLANT MATERIAL MUST BE FIRST QUALITY AND SHALL

COMPLY WITH THE MOST RECENT STANDARDS FOR NURSERY STOCK AS APPROVED BY THE AMERICAN STANDARDS INSTITUTE AND SPONSORED BY THE AMERICAN ASSOCIATION OF NURSERYMEN.

10. PLANTING - FOLLOW PLANTING DETAILS CAREFULLY. ALL PLANTS SHALL BE PRUNED AS NEEDED IMMEDIATELY AFTER INSTALLATION TO PROMOTE VIGOROUS GROWTH. CONTRACTOR SHALL REMOVE TREE STAKING AND WRAP WITHIN 18 MONTHS OF INSTALLATION.

11. CONTRACTOR TO REVIEW AND VERIFY SITE CONDITIONS COMPARED TO PLANS. THESE ARE NOT ENGINEERED DRAWINGS, AND FIELD ADJUSTMENTS MAY BE NECESSARY DUE TO ACTUAL UTILITY LOCATIONS, STRUCTURES, OBJECTS OR CONDITIONS THAT ARE DIFFERENT THAN SHOWN ON THESE


12. HAVE ALL UTILITIES LOCATED BEFORE CONSTRUCTION. COORDINATE ALL WORK WITH OTHER TRADES.

13. NATIVE SEEDING - AREAS DESIGNATED AS NATIVE GRASS SEED SHALL BE DRILLED WITH NATIVE PRAIRIE MIX @ 3# /1000 SF FROM PAWNEE BUTTES SEED CO. 970-356-7002.GROUND OF SEEDED AREA SHALL BE CULTIVATED LIGHTLY THEN SEEDED IN TWO DIRECTIONS TO DISTRIBUTE THE SEED EVENLY OVER ENTIRE AREA. AFTER SEEDING, THE AREA SHALL BE CRIMPED WITH STRAW. CONTRACTOR SHOULD MONITOR SEEDED AREA FOR EROSION CONTROL AND GERMINATION, RESEEDING AS NEEDED TO OBTAIN EVEN COVERAGE OF GRASS.

SUMMARY OF PROJECT STATISTICS

Note: Trees and shrubs along street frontages (North and East) have been increased by 5% to compensate for F.A.R.

a.) Square footage of landscape area:	169,455	5 sf
b.) Square footage of sod and percent of total landscape area:	19,865 sf	11.7%
c.) Square footage of living plant material and percent of total landscape area:	164,957 sf	97.4 %
d.) Number of trees required (per City ordinance):	103	
e.) Number of trees provided:	122	
f.) Number of shrubs required (per City ordinance):	559	
g.) Number of shrubs provided:	663	
h.) Number of mulch types: (Rock mulch + wood mulch on perennials and grou	ndcover) 2	

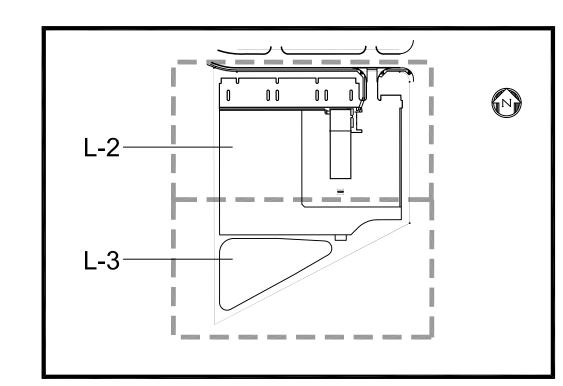

SHEET KEY NOT TO SCALE

GENERAL NOTES

A.) MINIMUM PLANT SIZE REQUIREMENTS AND SOIL PREPARATION: MINIMUM PLANT SIZE REQUIREMENTS ARE 2-INCH DIAMETER (CALIPER) FOR DECIDUOUS TREES, 1.5-INCH DIAMETER FOR ORNAMENTAL TREES AND 6-FOOT HEIGHT FOR EVERGREEN TREES. MINIMUM SIZE REQUIREMENTS FOR SHRUBS IS #5 GALLON CONTAINER; ORNAMENTAL GRASSES ONE GALLON CONTAINER; PERENNIALS AND GROUND COVERS 2 1/4 POTS. PLANTS SHOULD BE MIXED APPROXIMATELY 50 CONIFEROUS (EVERGREEN) AND 50% DECIDUOUS (TREE LAWN AREAS BETWEEN CURBS AND DETACHED WALKS SHALL BE ALL DECIDUOUS SHADE TREES) MINIMUM SOIL PREPARATION FOR PLANTING SHALL BE 5 CUBIC YARDS OF ORGANIC SOIL AMENDMENT TILLED TO A DEPTH OF 6 INCH FOR EVERY 1,000 S.F. OF LANDSCAPE AREA.

B.) STREET TREES: THE DEPARTMENT OF COMMUNITY DEVELOPMENT HAS IDENTIFIED SPECIFIC DECIDUOUS TREE SPECIES TO BE PLANTED WITHIN TREE LAWN AREAS. ALL TREES CHOSEN FOR TREE LAWN APPLICATIONS MUST BE SELECTED FROM THE APPROVED CITY LIST

C.) WEED BARRIER: POROUS WEED FABRIC MUST BE USED IN PLANTED BEDS FOR WEED PREVENTION, BECAUSE IT ALLOW VENTILATION FOR ROOTS AND TRANSMISSION OF WATER. PLASTIC WEED BARRIERS IN ANY PLANTED AREA WILL NOT BE APPROVED.

D.) EDGING: PLASTIC OR FIBERGLASS EDGING IS FAVORABLE TO METAL HOWEVER, METAL EDGING MAY BE USED PROVIDED IT HAS A ROLLOVER TOP OR A PROTECTIVE CAP IS INSTALLED. E.) MAINTENANCE:

(1) THE DEVELOPER, HIS SUCCESSORS AND ASSIGNS, SHALL BE RESPONSIBLE FOR INSTALLATION, MAINTENANCE AND REPLACEMENT OF ALL LANDSCAPING MATERIALS SHOWN OR INDICATED ON THE APPROVED SITE PLAN, DEVELOPMENT PLAN, OR LANDSCAPE PLAN, INCLUDING THOSE AREAS FOUND IN THE RIGHT-OF-WAY.

(2) LANDSCAPING SHALL BE CONTINUOUSLY MAINTAINED INCLUDING NECESSARY WATERING, WEEDING, PRUNING, PEST CONTROL, AND REPLACEMENT OF DEAD OR DISEASED PLANT MATERIAL. REPLACEMENT OF DEAD OR DISEASED PLANT MATERIAL SHALL BE OF THE SAME TYPE OF PLANT MATERIAL AS SET FORTH IN THE APPROVED SITE PLAN; FOR EXAMPLE, A TREE MUST REPLACE A TREE, A SHRUB MUST REPLACE A SHRUB, ETC. REPLACEMENT SHALL OCCUR IN THE NEXT PLANTING SEASON, BUT IN ANY EVENT, SUCH REPLACEMENT TIME SHALL NOT EXCEED ONE (1) YEAR.

(3) THIS APPROVED SITE PLAN, DEVELOPMENT PLAN, OR LANDSCAPE PLAN SHALL BE ON FILE IN THE PLANNING DEPARTMENT. ALL LANDSCAPING WILL BE INSTALLED AS DELINEATED ON THE PLAN, PRIOR TO ISSUANCE OF ANY


CERTIFICATE OF OCCUPANCY. F.) SIGHT LINE CONSIDERATIONS: ANY AREA DETERMINED BY THE CITY ENGINEER TO BE WITHIN A SIGHT DISTANCE-TRIANGLE MAY NOT CONTAIN PLANT MATERIAL THAT AT THE TIME OF PLANTING OR AT MATURITY EXCEEDS 36INCHES ABOVE THE GUTTER FLOW LINE EXCEPT TREES WHICH MUST BE LIMBED TO 8 FEET AT ADEQUATE MATURITY. TREES SHALL BE PLANTED A MINIMUM OF TEN FEET FROM INTERSECTIONS AND FIFTEEN FEET FROM LIGHT OR UTILITY POLES. ALL OTHER LANDSCAPE FEATURES SHALL NOT EXCEED 36 INCHES WITHIN SIGHT

DISTANCE-TRIANGLES. INFORMATION ON SIGHT DISTANCE TRIANGLES MAY BE OBTAINED FROM THE CITY OF COMMERCE CITY ENGINEERING STANDARDS AND SPECIFICATIONS -SECTION 3.03.2 TABLE 3-1. G.) IMPLEMENTATION AND COORDINATION OF LANDSCAPE PLAN: THE DEVELOPER


SHALL ENSURE THAT THE LANDSCAPE PLAN IS CLOSELY COORDINATED WITH PLANS PREPARED BY OTHER CONSULTANTS SO THAT THE PROPOSED GRADING, STORM DRAINAGE OR OTHER CONSTRUCTION DOES NOT CONFLICT WITH OR PRECLUDE THE INSTALLATION AND MAINTENANCE OF LANDSCAPE ELEMENTS AS DESIGNATED ON THE LANDSCAPE PLAN.


H.) IRRIGATION: ALL LANDSCAPED AREA AND PLANT MATERIALS, EXCEPT FOR NON IRRIGATED NATIVE, RESTORATIVE, AND DRY LAND GRASS AREAS MUST BE WATERED BY AN AUTOMATIC UNDERGROUND IRRIGATION SYSTEM. IRRIGATION SYSTEM DESIGN, INSTALLATION, OPERATION, AND MAINTENANCE SHALL CONFORM TO THE REQUIREMENTS OF SOUTH ADAMS COUNTY WATER AND SANITATION DISTRICT. APPROVAL OF THIS LANDSCAPE PLAN DOES NOT CONSTITUTE APPROVAL FROM SOUTH ADAMS COUNTY WATER AND SANITATION DISTRICT FOR ANY IRRIGATION SYSTEM. ALL IRRIGATION PLANS, OR PORTIONS THEREOF, DESIGNED FOR PUBLIC RIGHT-OF-WAYS SHALL SPECIFY PARTS / COMPONENTS FROM THE CITY APPROVED IRRIGATION PARTS/COMPONENT LIST. I.) NATIVE GRASS NOTE: ALL AREAS OF THE LOT NOT PAVED OR FORMALLY LANDSCAPED, SHALL BE, AT A MINIMUM, SEEDED WITH NATIVE GRASSES. J.) VEHICLE PARKING NOTE: NO VEHICLE PARKING IS ALLOWED IN ANY LANDSCAPE TREATMENT AREA.

PLANTING DETAILS

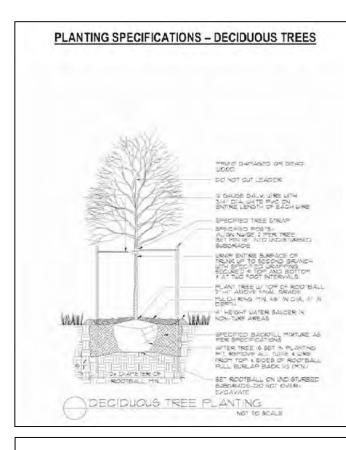



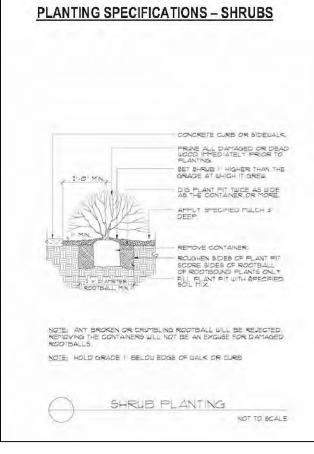

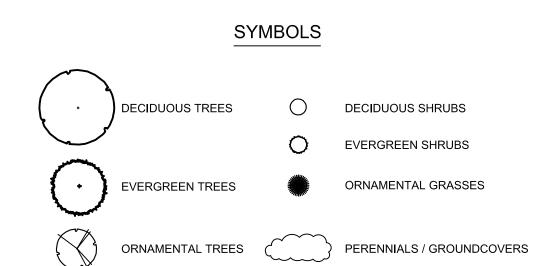

NON-IRRIGATED NATIVE SEEDING

CITY STAFF CERTIFICATE

DEPARTMENT OF COMMUNITY

DEVELOPMENT SERVICES SIGNATURE

IRRIGATED TURF

APPROVED BY THE DEPARTMENT OF COMMUNITY DEVELOPMENT OF THE CITY OF COMMERCE CITY, THIS _____DAY OF ____A.D. ____

PREPARED BY:

SITE DESIGN

970-217-9169 www.sitedesign-llc.com P.O. Box 51 Loveland, CO 80539 Tim Briggs RLA, ASLA



(303) 289 - 3373CONTACT: LEE BOULDIN

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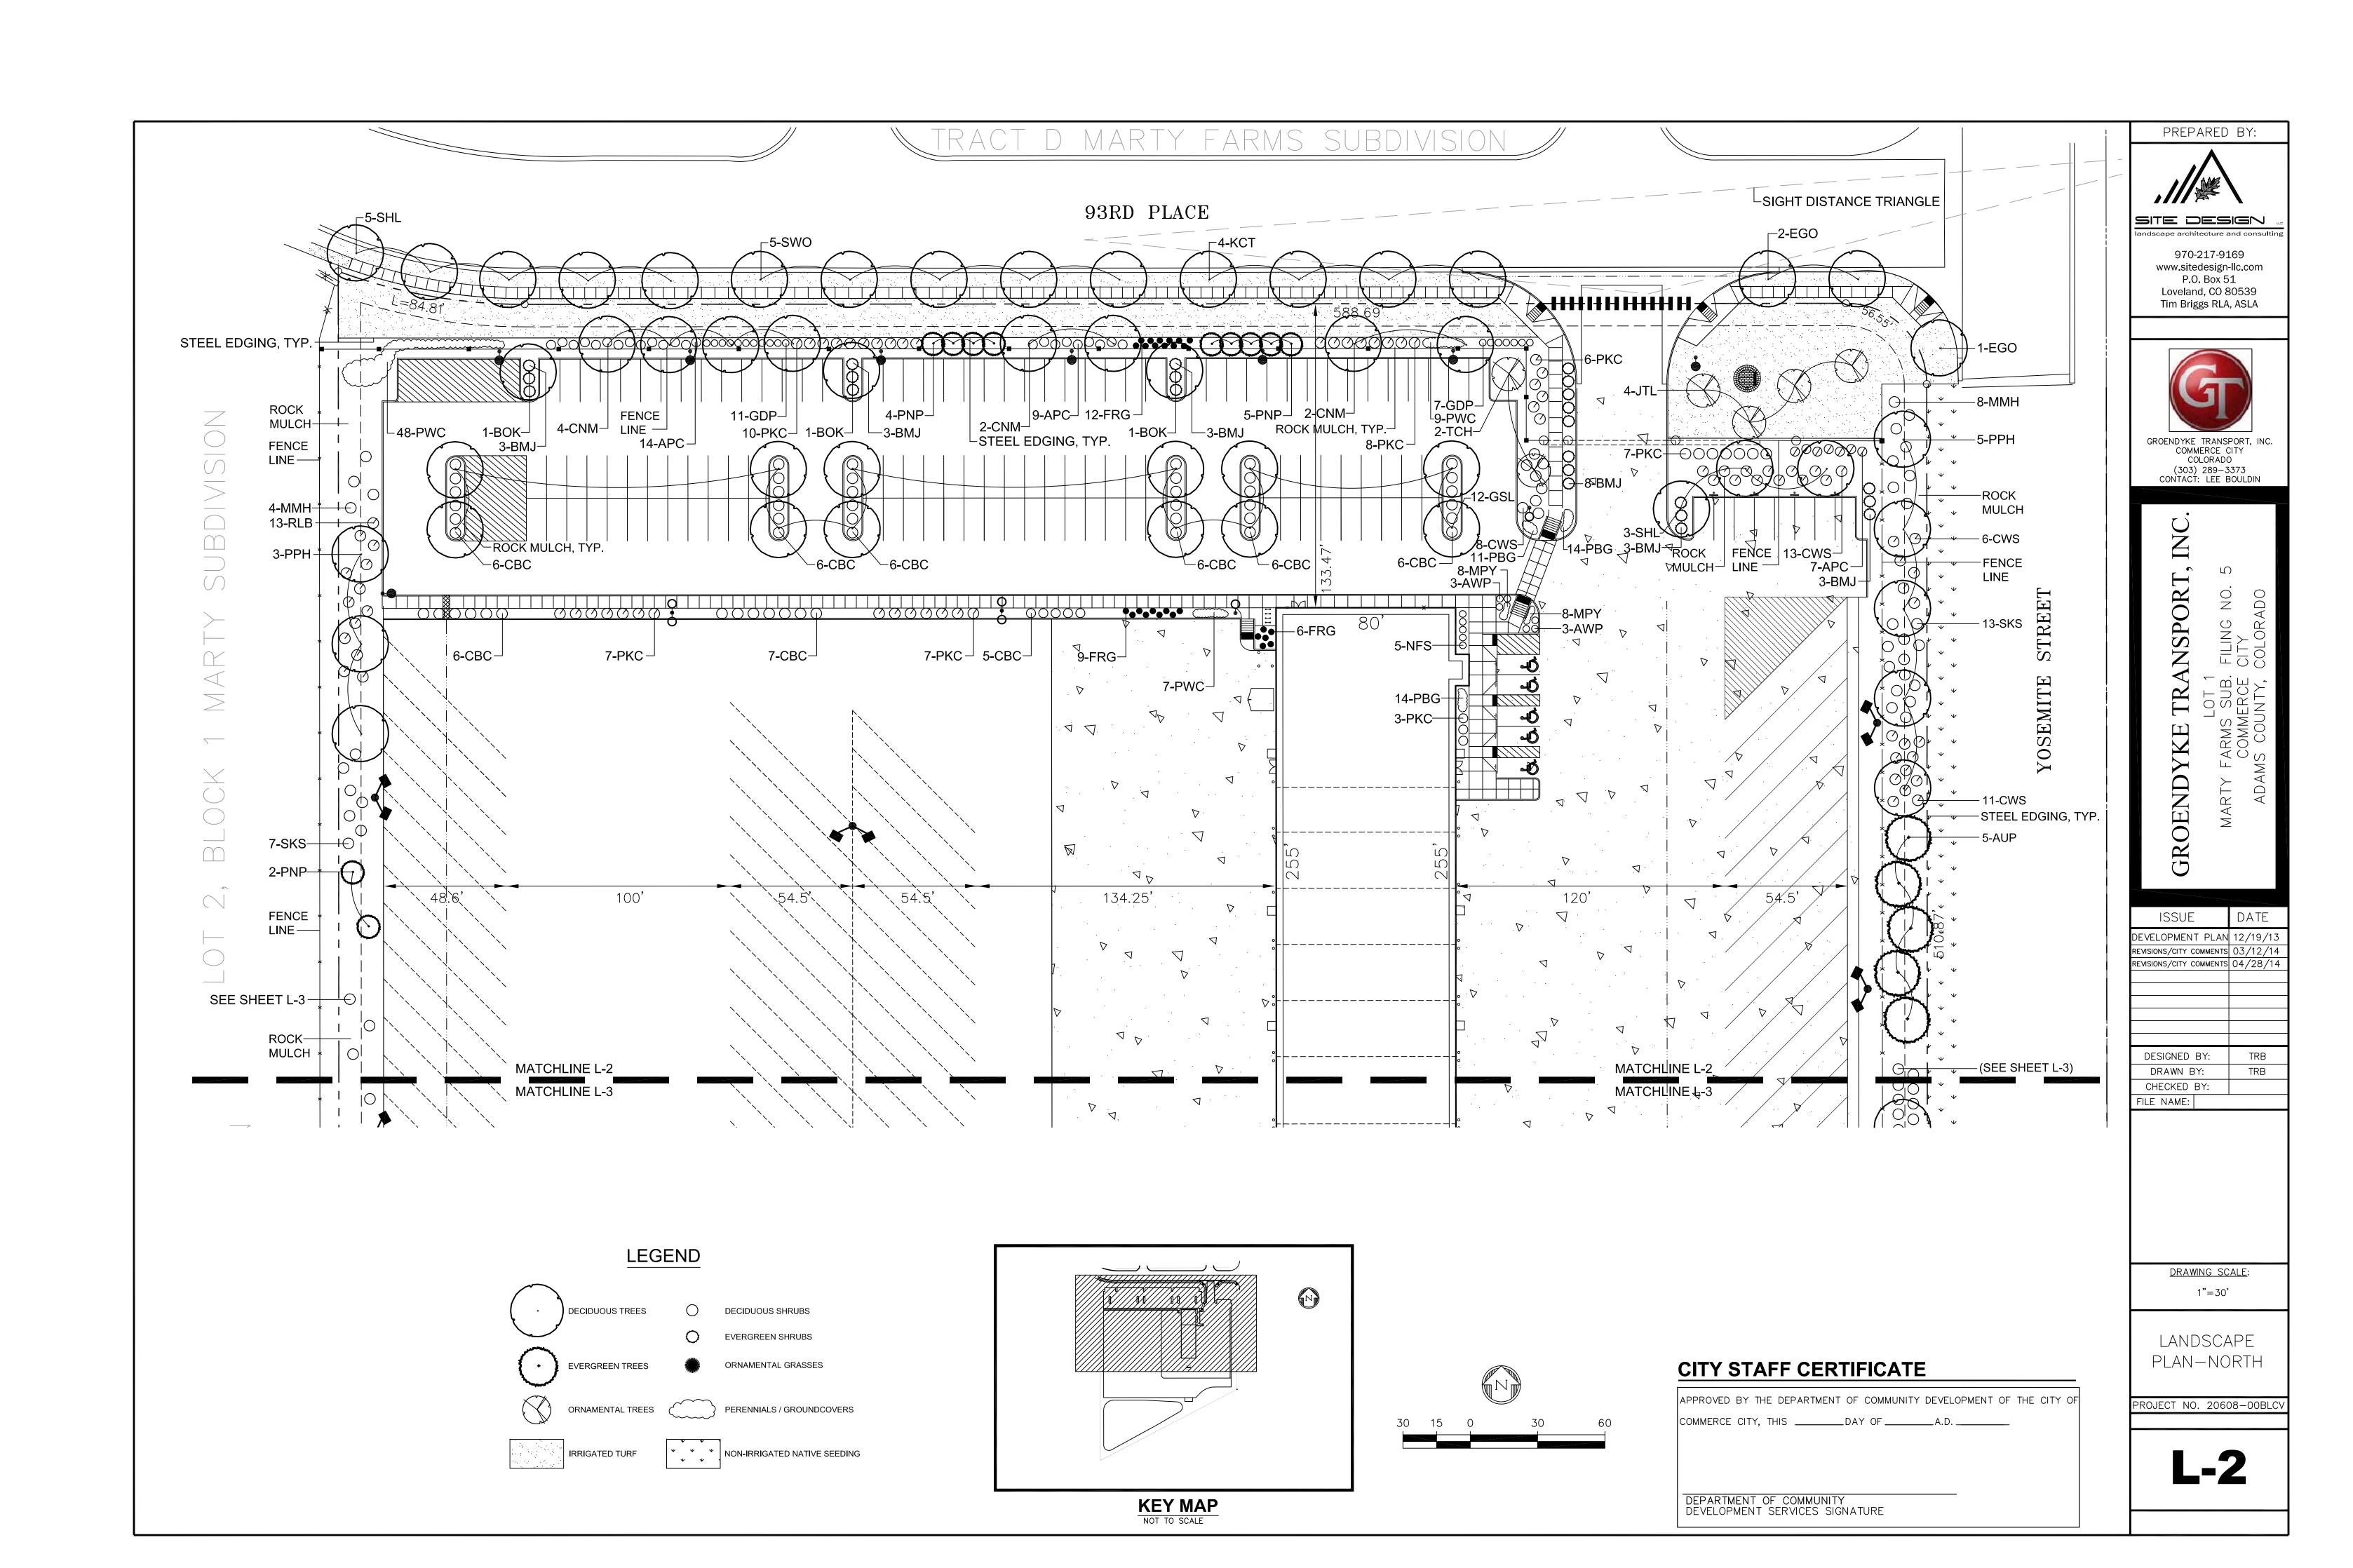
ISSUE	DATE
DEVELOPMENT PLAN	12/19/13
REVISIONS/CITY COMMENTS	03/12/14
REVISIONS/CITY COMMENTS	04/28/14
DESIGNED BY:	TRB
DRAWN BY:	TRB
CHECKED BY:	


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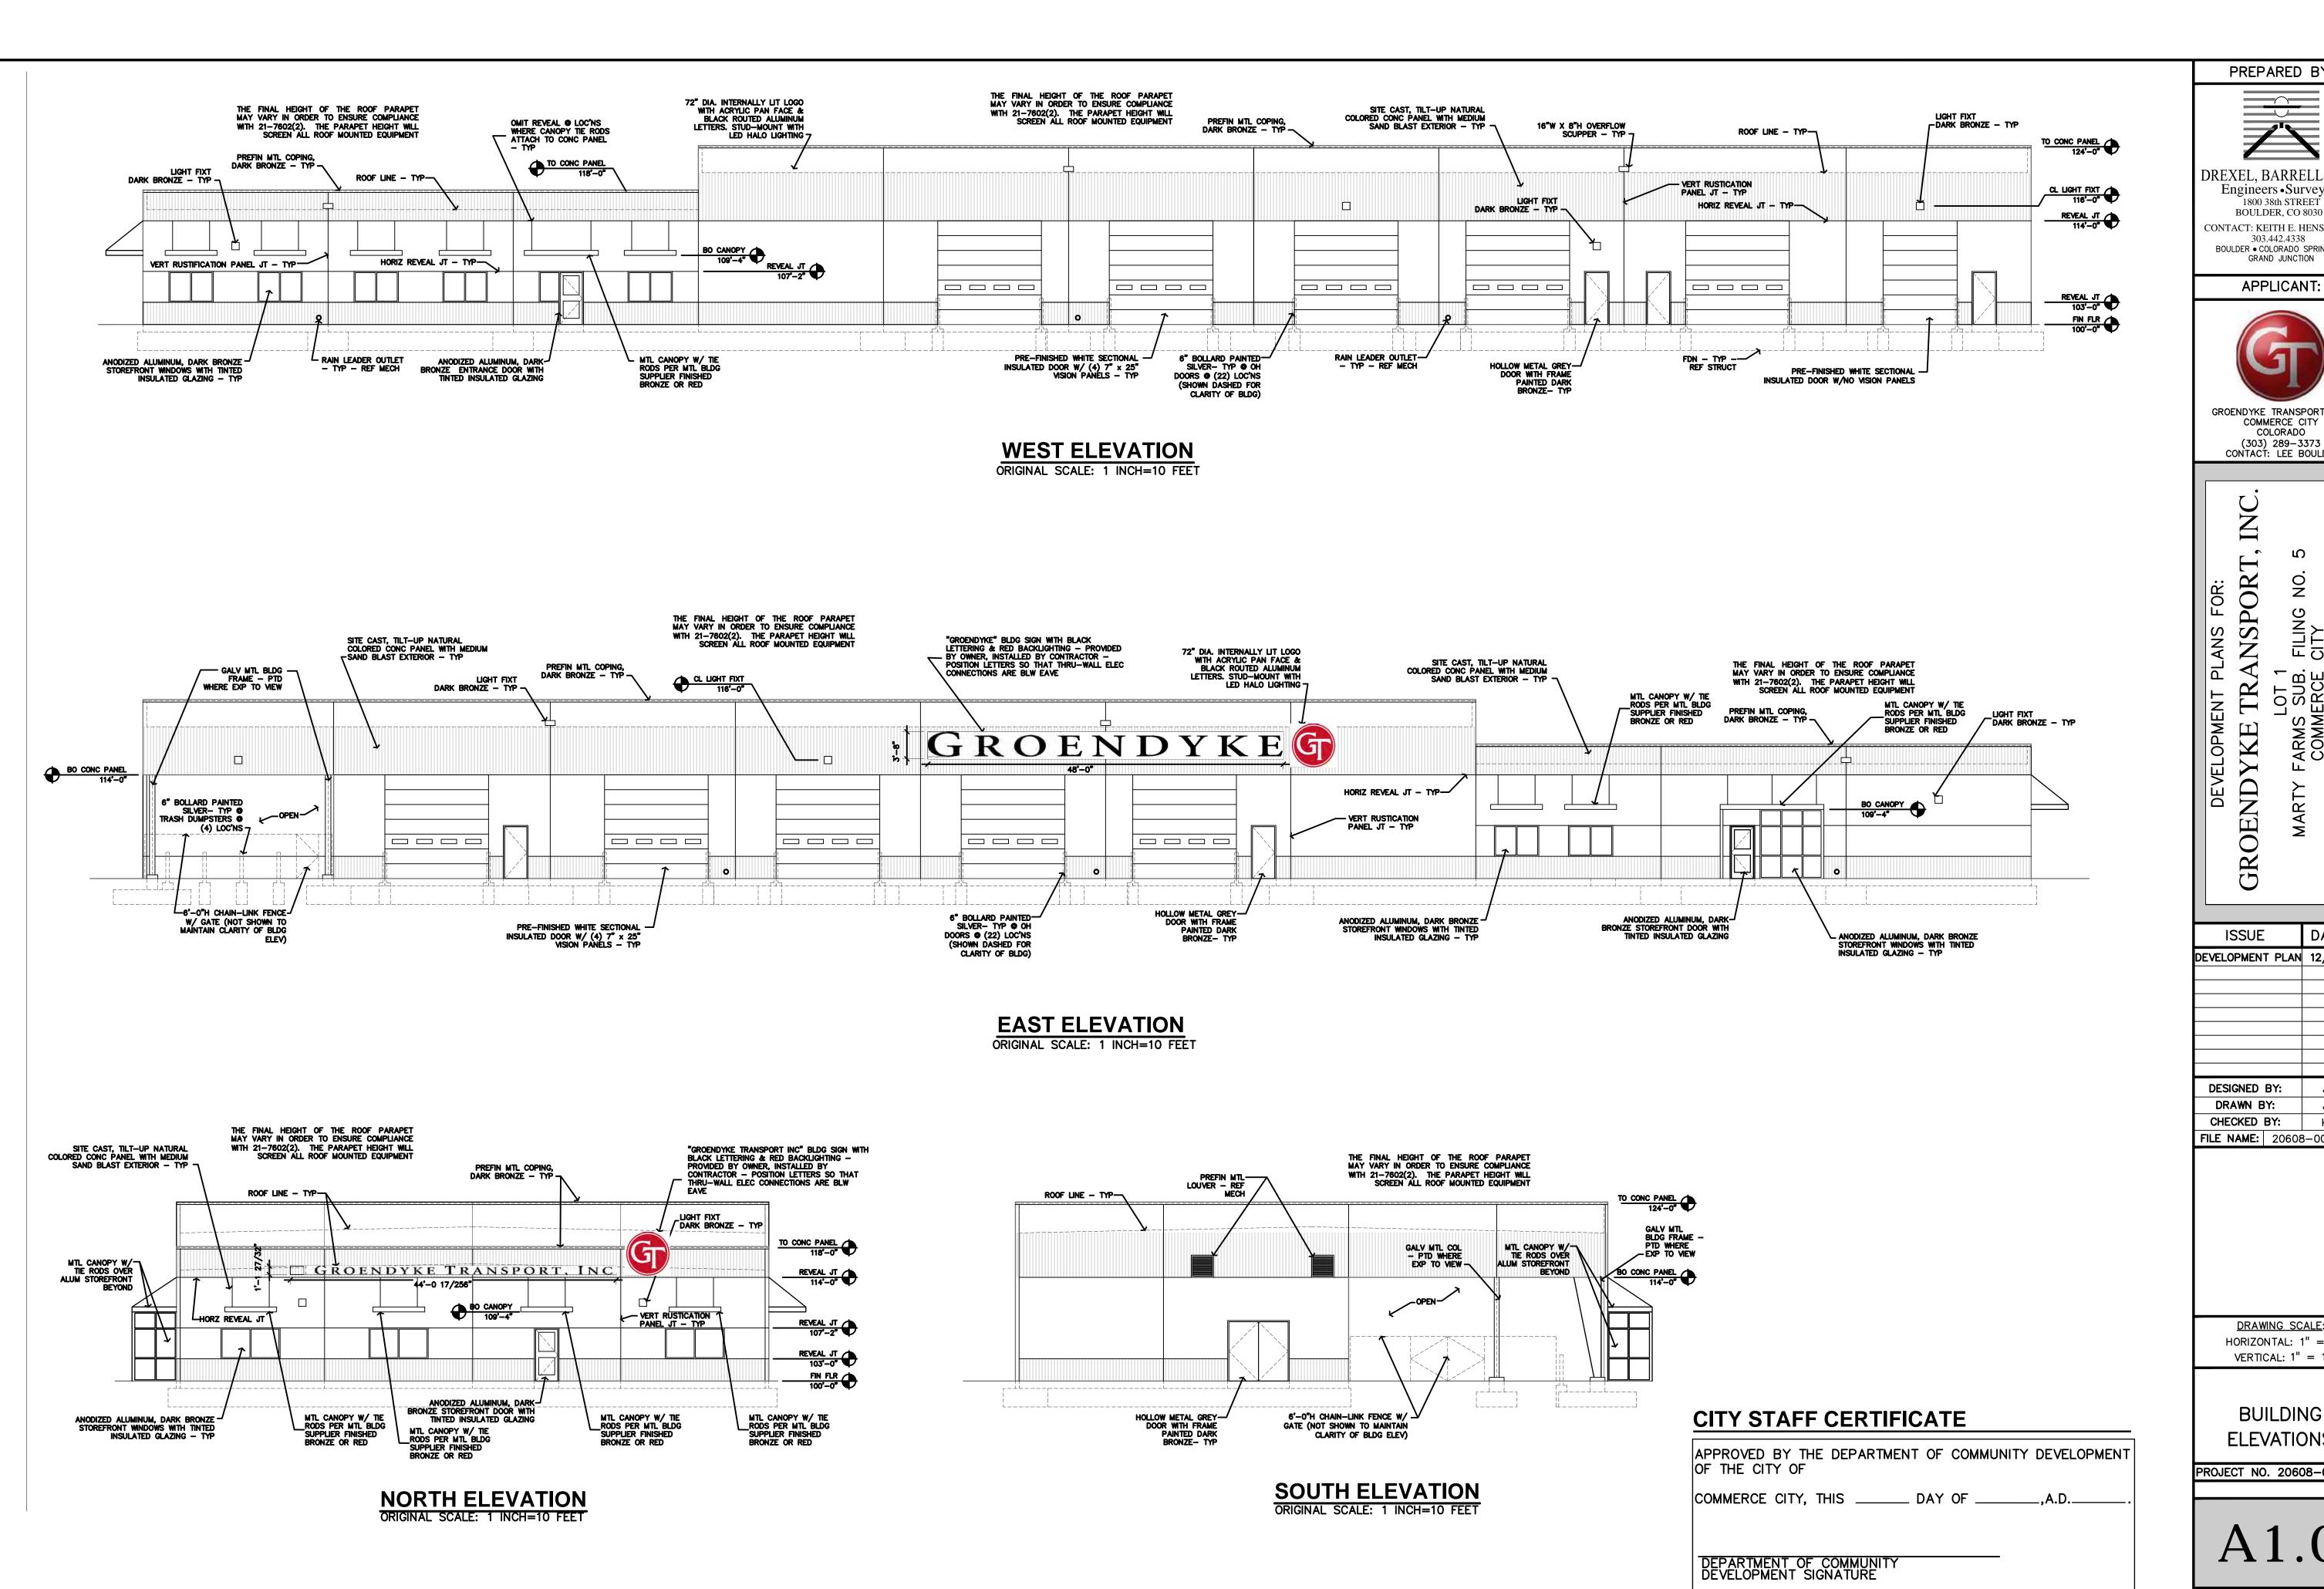
DRAWING SCALE:

LANDSCAPE COVER-SHEET NOTES_&_DETAILS

PROJECT NO. 20608—00BLCV





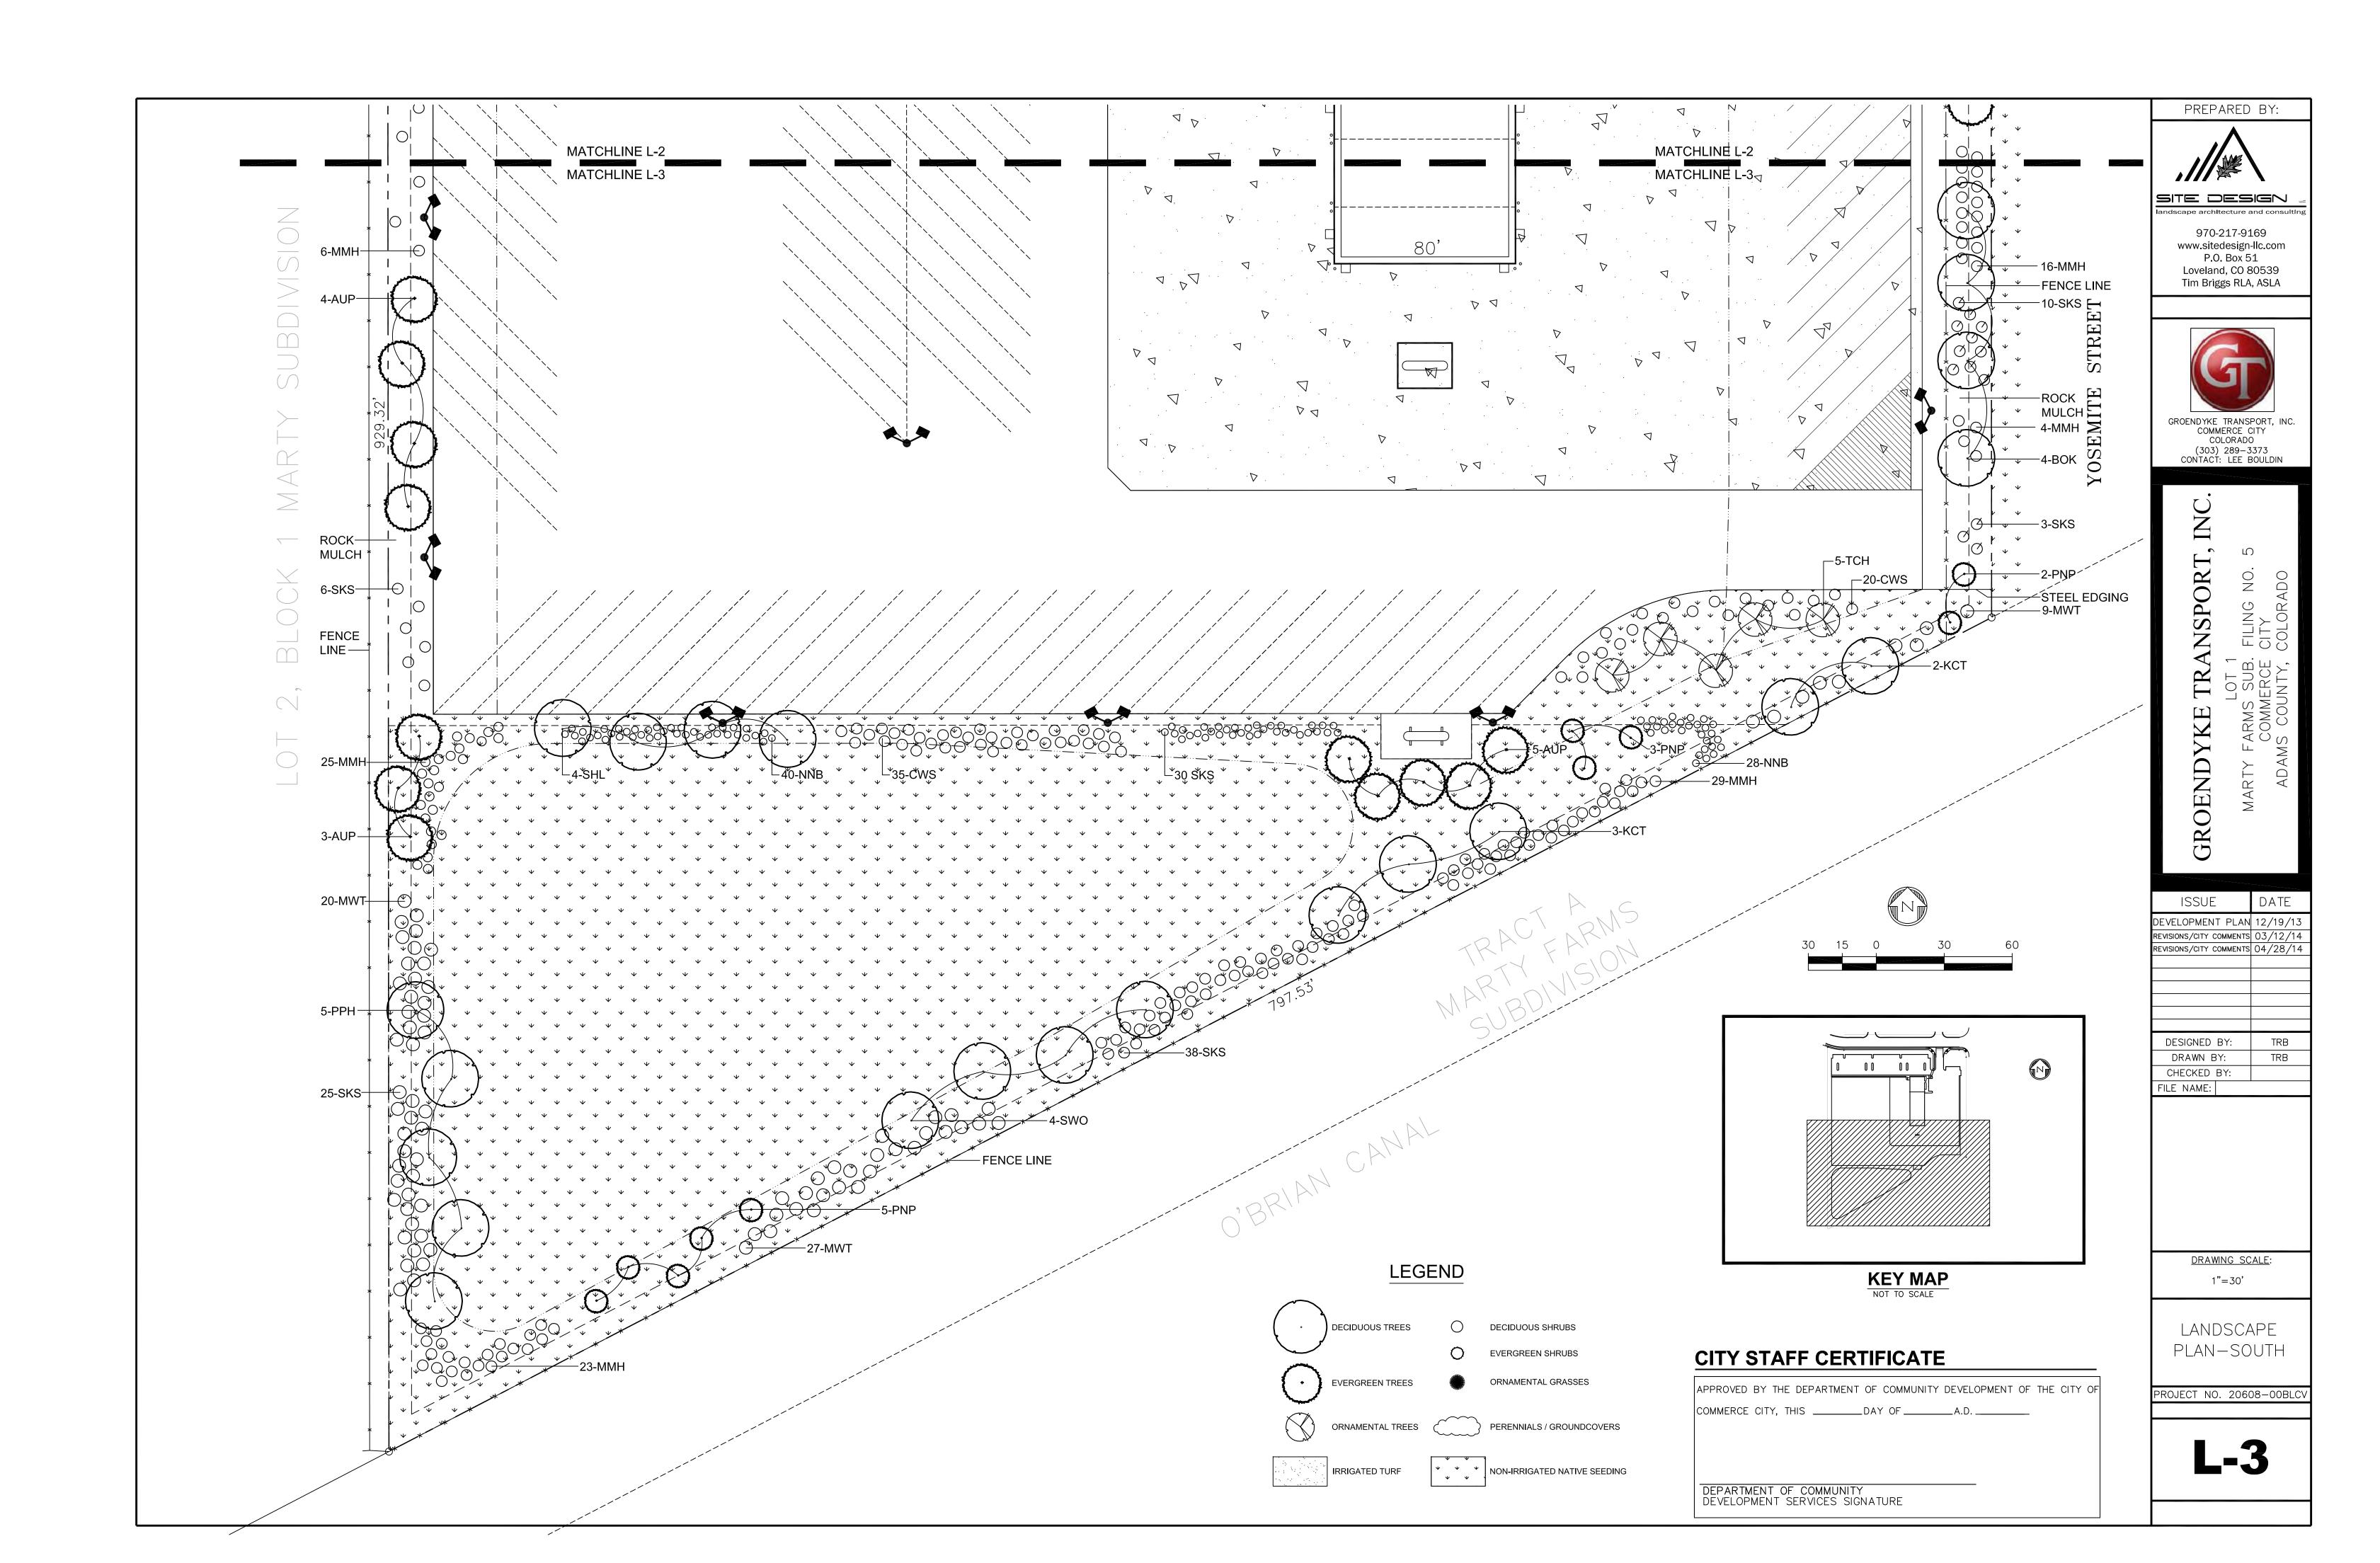

PREPARED BY:

DREXEL, BARRELL & CO. Engineers • Surveyors 1800 38th STREET BOULDER, CO 80301 CONTACT: KEITH E. HENSEL, P.E. 303.442.4338 BOULDER • COLORADO SPRINGS

APPLICANT:



GROENDYKE TRANSPORT, INC. COMMERCE CITY COLORADO (303) 289-3373 CONTACT: LEE BOULDIN

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DATE DEVELOPMENT PLAN 12/6/13


DESIGNED BY: CHECKED BY: FILE NAME: 20608-00ARCH1

> DRAWING SCALE: HORIZONTAL: 1'' = 10''VERTICAL: 1" = 10"

BUILDING **ELEVATIONS**

PROJECT NO. 20608-00BLCV

SHEET: 14 OF 16

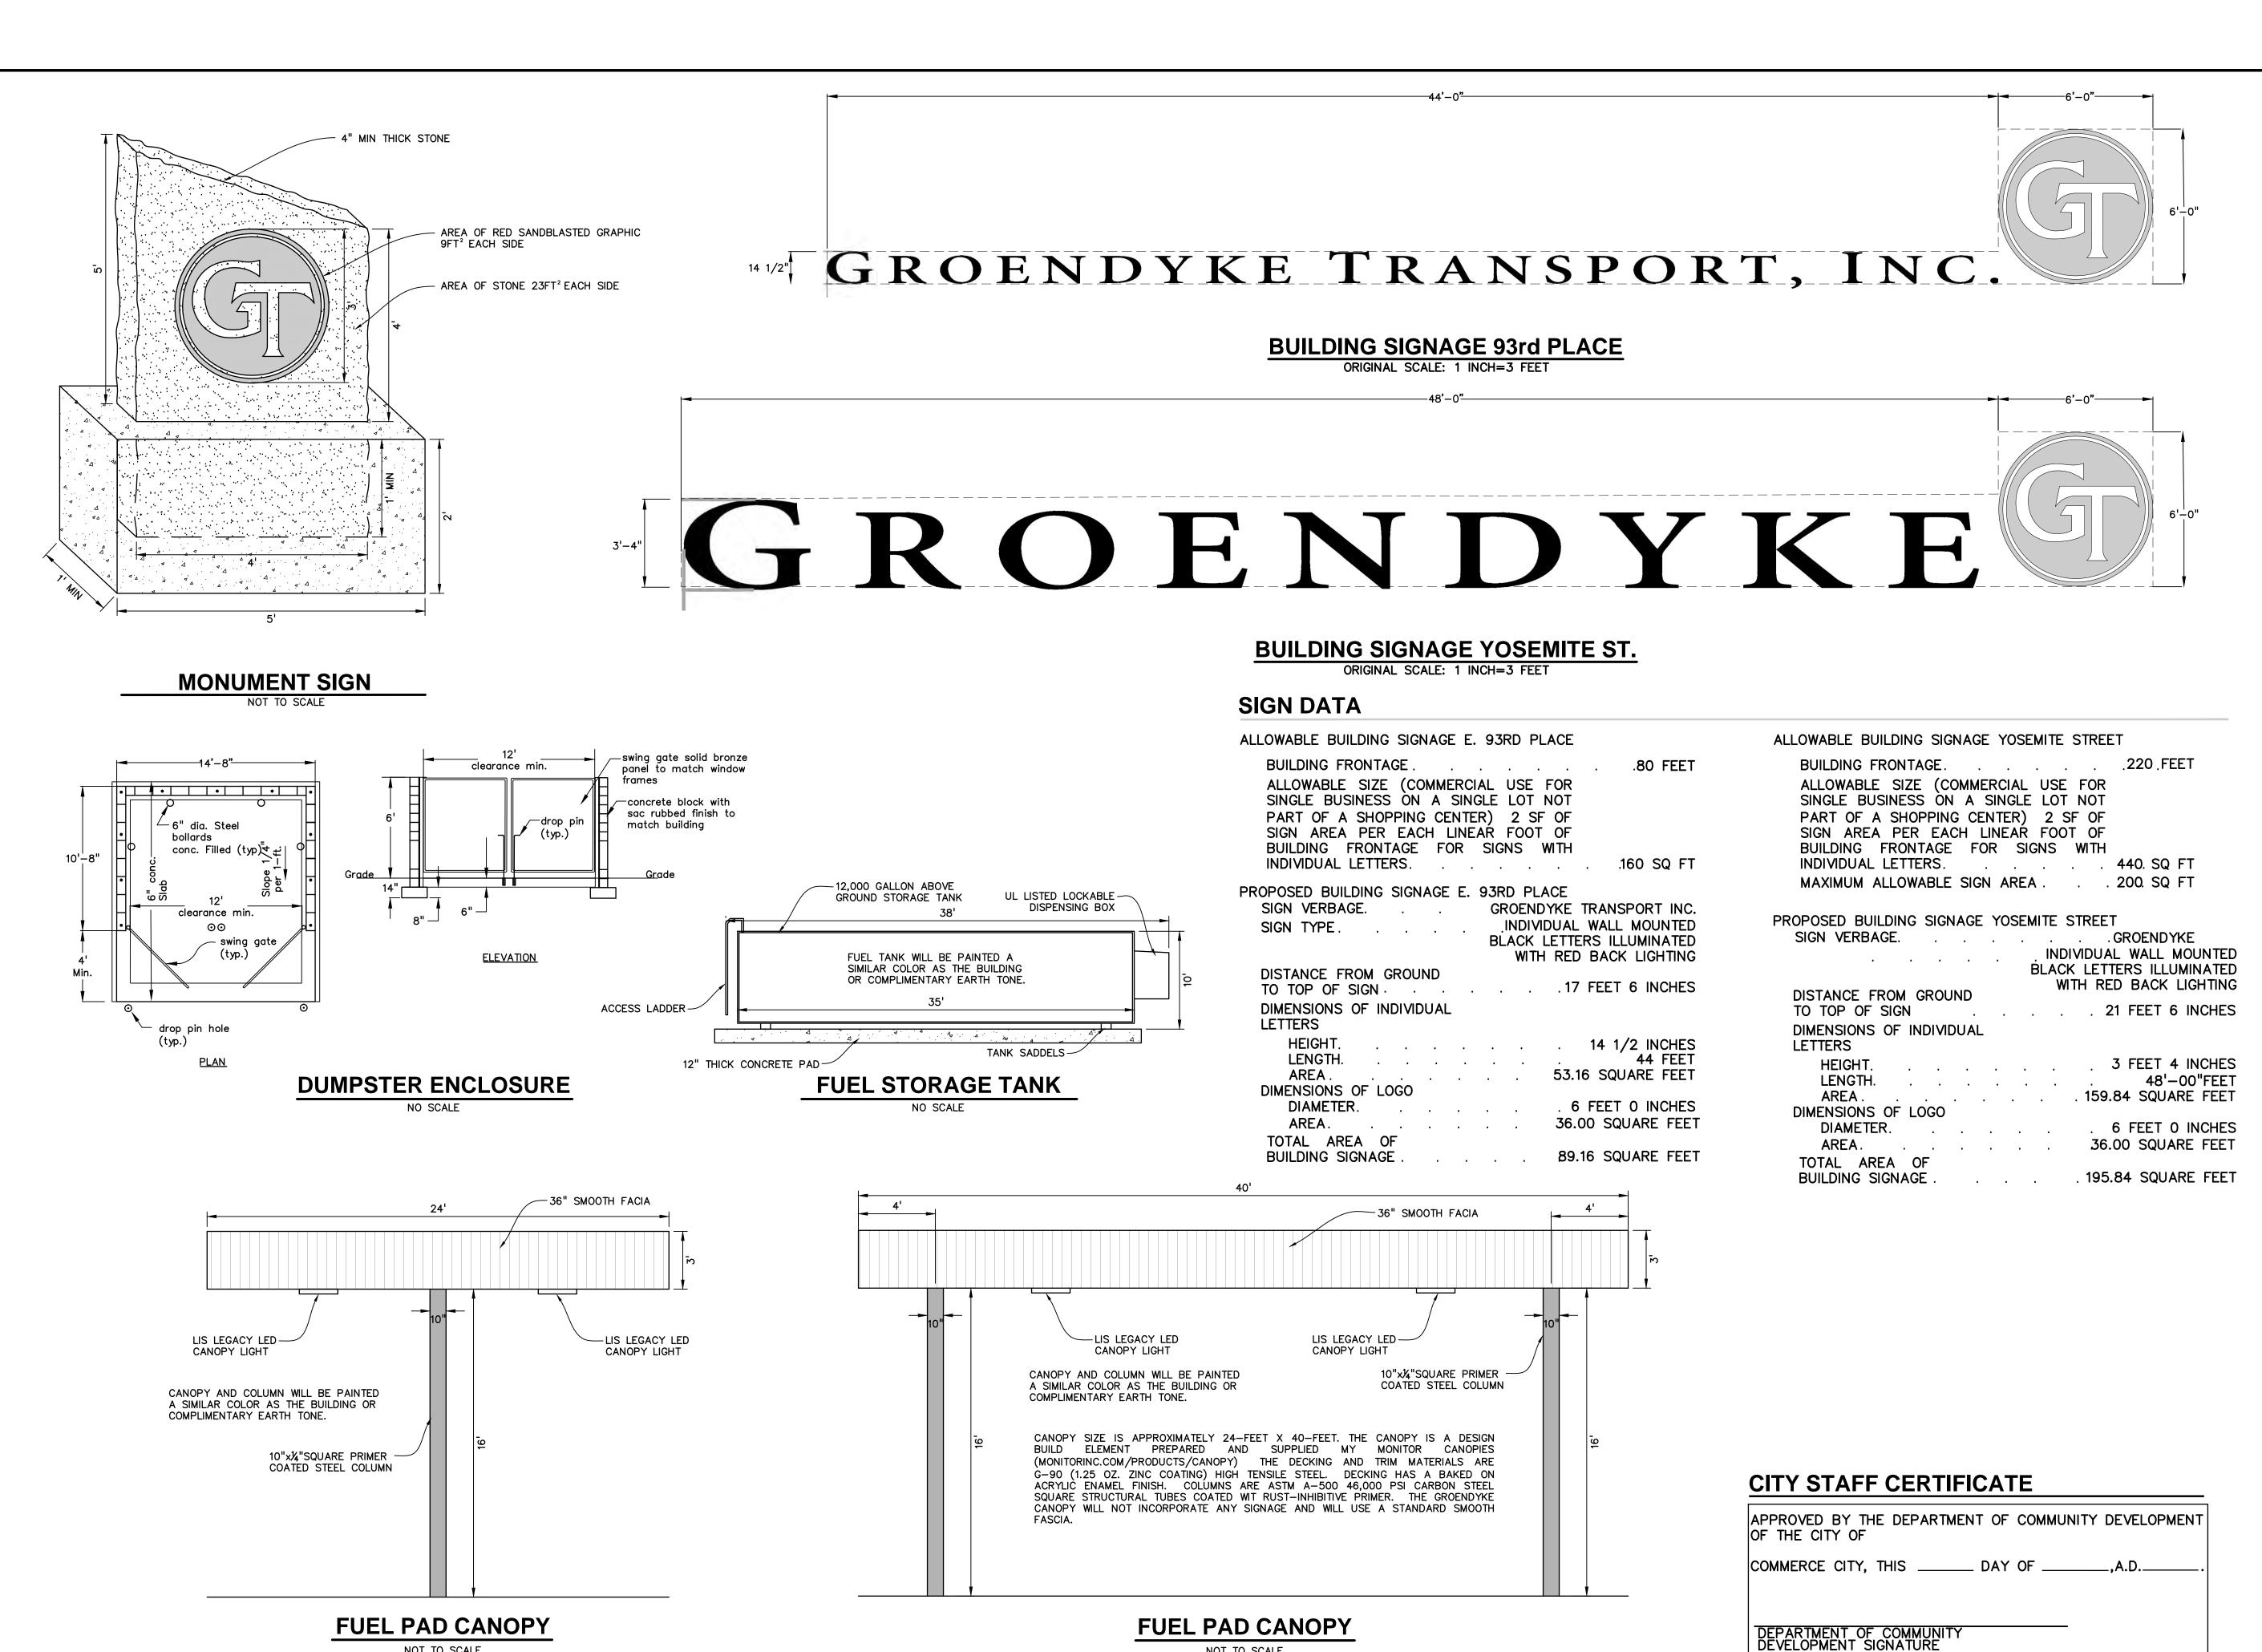

NOT TO SCALE

PREPARED BY

Engineers • Surveyors 1800 38th STREET BOULDER, CO 80301 CONTACT: KEITH E. HENSEL, P.E 303.442.4338 BOULDER . COLORADO SPRINGS

GRAND JUNCTION

APPLICANT:



COMMERCE CITY COLORADO (303) 289-3373 CONTACT: LEE BOULDIN

ISSUE DATE DEVELOPMENT PLAN 12/6/13

DESIGNED BY: DRAWN BY: CHECKED BY: FILE NAME: 20608-00ARCH1

> DRAWING SCALE: HORIZONTAL: X'' = XX''VERTICAL: X'' = XX''

BUILDING **ELEVATIONS**

PROJECT NO. 20608-00BLCV

SHEET: 15 OF 16

